

October 16, 2020

City of Detroit – Planning & Development Department 2 Woodward Avenue, Suite 808 Detroit, MI 48226

Re: 208 Mack Avenue

Detroit, MI 48201

PROJECT INFORMATION

The roof at the historic Albert Kahn Residence is at the end of its lifespan and requires replacement. This project will replace the failing roof with a historically appropriate terracotta tile. Existing areas of composite roof will be replaced with a membrane roof. Damaged and/or inoperable gutters and downspouts will also be replaced.

DESCRIPTION OF EXISTING CONDITIONS

This project site is located in the Brush Park Historic District listed on the US National Register of Historic Places. The house was designated a Michigan State Historic Site on December 7, 1971 and listed on the National Registry for Historic Places on October 18, 1972.

Originally built as the Albert Kahn residence, the house is approximately 5,900 square feet of space. The original house was designed and built in 1907 with minor modifications in 1921, which contains 1,650sf on the first floor and 1,650sf on the second floor. The 1928 addition was designed to house a library and gallery for art collection, as well as a six-car garage and servant's quarters accessed from the back alley. The addition contains 1,600sf on the first floor, 1,000sf on the second floor, and a 1,200sf attached garage.

Albert Kahn continued to live in his home with his wife and four children until his death in 1942. The Urban League of Detroit and South East Michigan (ULDSEM) currently uses the first floor of the building for offices, receptions and large gatherings, with additional offices occupying the second floor. Much of the original architecture remains, however the ULDSEM has subdivided some spaces to gain office space and additional support spaces.

The home is in the English Renaissance style, constructed with stone trim on the lower half and stucco above with a terracotta tile roof. It is a two-story home with an attic and dormer windows. The house is soundproof and fireproof, with each floor constructed of reinforced concrete with wooden sleepers over top, supporting finished wood floors.

The existing terracotta roof is original to the building. There are many missing, broken, and cracked roof tiles. Flashings are in need of repair or replacement. Exterior wood elements continue to deteriorate due to continued exposure to the elements. Missing areas of tile have been patched in spots with a membrane and in other areas are left bare. This has led to exterior and interior deterioration caused by water infiltration. The roof is at the end of its lifespan and is in need of replacement. The Detroit Urban League has been awarded a grant from the National Park Service to replace the roof in a manner complying with historic requirements.

Proposal for Roof Replacement – Urban League of Detroit June 9, 2020 Page 2

The existing roof tile is a smooth red clay terracotta tile nailed to wood sleepers on a tongue-and-groove wood underlayment on wood rafters. Where the tiles have been exposed to the elements they have acquired a dark uneven patina. Portions of unexposed tile have an even red clay finish with little color variation.

The house's many dormers have a tile roof which matches the main roof field. The dormer's vertical faces are also clad in terracotta which has been painted pink in recent years (see A-201). The fascia, gutters and downspouts have also been painted pink.

DESCRIPTION OF PROJECT

This project includes the replacement of the tile roof and dormers with like material. The existing terracotta tile will be removed and replaced with new tile. The new roof and dormer tile will match the color of the original tile instead of the patina color. Associated roof trim, gutters, downspouts, and leader boxes will be painted to match the new roof tile. The resulting roof will appear uniform in color across the roof field, dormers and accessories. This matches the original color scheme of the building.

Existing gutters, downspouts and trim will be repaired and/ or replaced as existing conditions require. The replacement items are specified to match existing.

The areas of roof that were originally composite will be removed and replaced with an elastomeric roof membrane (EPDM). These areas are not visible from the street and this matches the original design.

DETAILED SCOPE OF WORK

Roof and Gutter Replacement

- Miscellaneous repairs to roof frame/structure
- Flashing replacement / repairs
- Ice & weather shield underlayment membrane
- New clay tile roof tile system (appropriate for Michigan climate)
- Replace copper valleys
- Replace flat / low slope roofs
- Miscellaneous roof accessories
- Horizontal gutters
- Vertical down spouts
- Accessories / collector boxes

ATTACHMENTS

Completed Building Permit Application
Architectural Drawings
Brochures and Cut Sheets
Ludowici Terracotta Tile
EPDM Roofing
Gutters and Downspouts

THIS IS A 3-PAGE FORM - ALL INFORMATION IS REQUIRED FOR PROJECT REVIEW

HISTORIC DISTRICT COMMISSION PROJECT REVIEW REQUEST

Data.

City of Detroit - Planning & Development Department 2 Woodward Avenue, Suite 808 Detroit, Michigan 48226

Detroit, Michigan 48226				Date	•	
PROPERTY INFOR	RMATION					
ADDRESS:			AKA:			
HISTORIC DISTRICT:_						
		Roof/Gutters/ Chimney	Porch/ Deck	Lands Tree/I	cape/Fence/ Park	General Rehab
`	New Construction	Demolition	Addition	Other	:	
APPLICANT IDEN	TIFICATION					
Property Owner/ Homeowner	Contracto	r	Tenant or Business Occu	pant	Archite Consu	ect/Engineer/ Itant
NAME:		COMPAN	NY NAME:			
ADDRESS:		CITY:	9	STATE:	ZIP:	
PHONE:	MOBILE:_		E	MAIL:		
PROJECT REVIEW	REQUEST CH	ECKLIST				
Please attach the follow *PLEASE KEEP FILE SIZE	ving documentation	n to your requ		r - -		
	ng Permit Applica				OTE: sed on the scop	e of work,
ePLANS Permit N		cable if you've	e already applie	i ado		entation may
	LL sides of existing	building or s	ite	i sco	pe-specific red	ni.gov/hdc for quirements.
Detailed photogra (photographs to she	•					
Description of exi	isting conditions ((including ma	terials and des	ign)		
Description of pro	oject (if replacing a er than repairof e					o why
Detailed scope of	work (formatted a	as bulleted lis	t)			
Brochure/cut she	e ets for proposed r	eplacement r	naterial(s) and	or produc	t(s), as appli	cable
Upon receipt of this documen	ntation, staff will review	and inform you o	of the next steps to	ward obtainir	ng your building	permit from the

Buildings, Safety Engineering and Environmental Department (BSEED) to perform the work.

SUBMIT COMPLETED REQUESTS TO HDC@DETROITMI.GOV

P2 - BUILDING PERMIT APPLICATION

			Da	te:
PROPERTY INFORMATI	ON			
Address:		Floor:	Suite#:	Stories:
AKA:				
Parcel ID#(s):				
Current Legal Use of Property				
Are there any existing buildin				No
PROJECT INFORMATIO	N			
Permit Type: New			emolition \square	Correct Violation
	nange of Use Temporal		_	
Revision to Original Permi				
Description of Work (Descri				
Description of Work	oe in detail proposed work and ask	or propert	y, attach work hat	
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Included Improvements (C	heck all applicable; these trade are	as require s	separate permit ap	plications)
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Structure Type			prinkler bysten	
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	ize of Structure to be Demoli	_	No	CUDIC TI
Construction involves change e.g. interior demolition or construc	· —	Yes	NO	
Jse Group:			Code Table 601)	
Estimated Cost of Construc	tion \$		<u>, </u>	
Estimated Cost of Construc	By Contractor		Ву	Department
	Office-Gross Floor Area		Industrial-Gro	oss Floor Area
	Institutional-Gross Floo			
Proposed No. of Employees:				
—— PLOT PLAN SHALL BE submitt				measurements
must be correct and in detail).	SHOW ALL streets abutting I	ot, indicat	e front of lot, sh	ow all buildings,
existing and proposed distance				vext Page)
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ntake By:	Date:	Fee	s Due:	DngBld? No
Permit Description:				
2			1	
Current Legal Land Use:				
Permit#:			_	
Zoning District:				
Lots Combined? Ye				
	oplications only) Old \$			
Structural:	<u> </u>			
Zoning:	Date:	N	otes:	
Other:	Date:	N	otes:	

IDENTIFICATIO	(All Fields Requ	ired)			
Property Owner/I	Homeowner	Property Ov	vner/Hom	eowner is Per	mit Applicant
Name:		Com	ipany Nan	ne:	
Address:		City:		State	::Zip:
Phone:		Mob	oile:		
Driver's License #:		Emai	l:		
Contractor	Contractor is Perm	nit Applicant			
Address:		City:		State	: Zip:
	Mobile:				
City of Detroit Lice	nse #:				
TENIANT OD DI	JSINESS OCCUPA	NIT T	enant is Pe	rmit Applicant	
	Phone:				
Traille.	Thone.			<u></u>	
ARCHITECT/EN	IGINEER/CONSU	LTANT .	Architect/E	ngineer/Consu	ultant is Permit Applicant
Name:	St	ate Registratio	n#:	Ехр	iration Date:
Address:		City:		State	Zip:
Phone:	Mobile:		En	nail:	
HOMEO	WNER AFFIDAVIT (Only required for r	residential p	ermits obtained	by homeowner.)
on this permit appl requirements of the inspections related	ication shall be compl e City of Detroit and ta	eted by me. I a lke full respons rk herein descri	m familiar ibility for a bed. I shal	with the appl Il code compl I neither hire	liance, fees and nor sub-contract to any
Print Name:	(Homeowner)	Signature:			Date:
					County, Michigan
Signature:	(Notary Public)		My Co	ommission Ex	pires:
		T APPLICANT			
L horoby cortify tha	t the information on t				vo raviowad all daad
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Print Name:	(Permit Applicant)	Signature:			Date:
	rn to before me this				County, Michigan
Signature:		Mv Cc	 mmission	Expires:	
	(Notary Public)				
Section (222 of the state cons	turetien eede	act of 10	72 1072042	20 MCI 125 1522A

Section 23a of the state construction code act of 1972, 1972PA230, MCL 125.1523A, prohibits a person from conspiring to circumvent the licensing requirements of this state relating to persons who are to perform work on a residential building or a residential structure. Visitors of Section 23a are subject to civil fines.

This application can also be completed online. Visit detroitmi.gov/bseed/elaps for more information.



HISTORIC DISTRICT COMMISSION REVIEW & PERMIT PROCESS

SUBMIT **COMPLETE APPLICATION** TO HDC STAFF **Application Staff** placed on Substantial Corrected **Reviews** upcoming HDC application Scope meeting Scope submitted agenda³ to HDC **HDC HDC** Staff **Applicant** issues Denial appeals OR Reviews **Denies** with Appeal corrects Scope Proposal Procedure application Appeal filed Staff issues a **HDC** w/State Certificate of **Approves** Hist. Pres. **Appropriateness** Review Board **Proposal** (COA)

OBTAIN BUILDING PERMIT


FROM BUILDINGS, SAFETY ENGINEERING AND ENVIRONMENTAL DEPT. (BSEED)

* THE **COMMISSION MEETS REGULARY AT LEAST ONCE PER MONTH,** TYPICALLY ON THE SECOND WEDNESDAY OF THE MONTH. (SEE WEBSITE FOR MEETING SCHEDULE/AGENDAS)

FIND OUT MORE AT WWW.detroitmi.gov/hdc

URBAN LEAGUE / KAHN HOME RESTORATION

DETROIT, MI

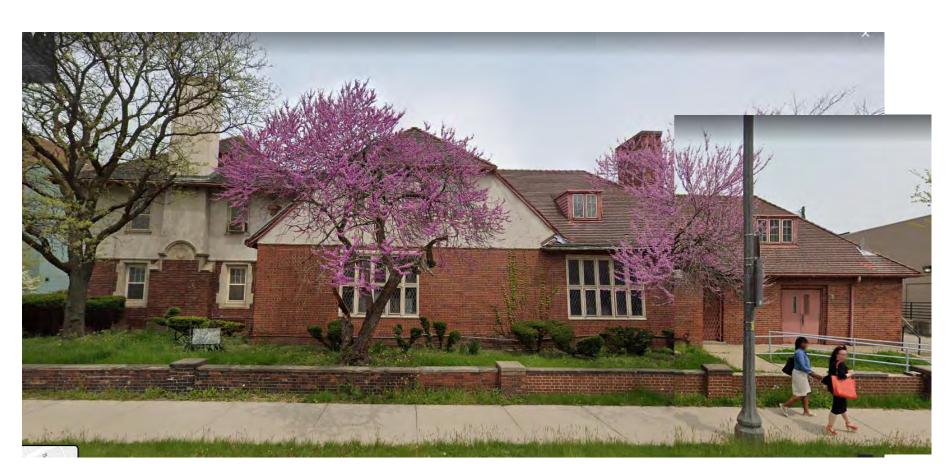







EXISTING COURTYARD NORTH ELEVATION

12" = 1'-0"
G-001 EXISTING COURTYARD WEST ELEVATION

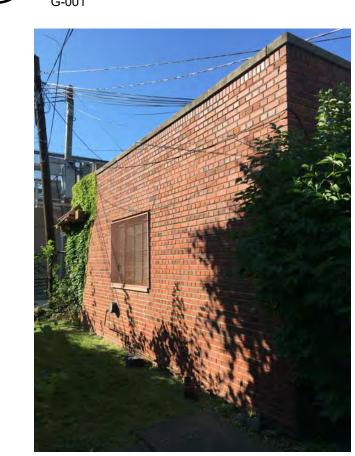

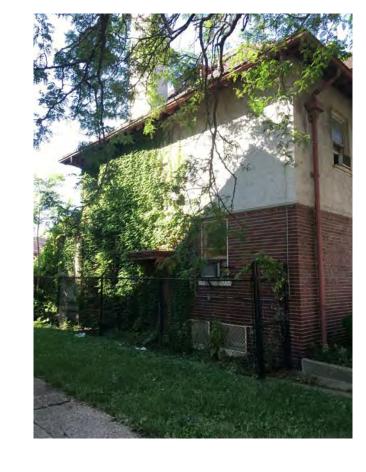

7 EXISTING EAST ELEVATION

12" = 1'-0"

G-001




EXISTING NORTH ELEVATION




EXISTING COURTYARD SOUTH ELEVATION



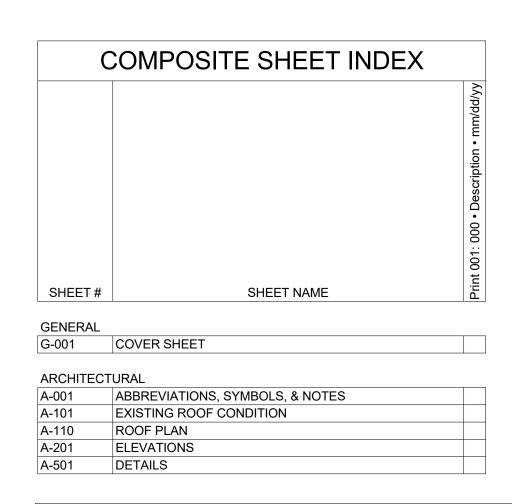

PROJECT TEAM	
(CLIENT) KEY CONTACTS	ARCHITECT/ ENGINEER
	albert KAHN
URBAN LEAGUE OF DETROIT & SEM 208 MACK AVE. DETROIT, MI 48201	ALBERT KAHN ASSOCIATES, INC. THE FISHER BUILDING 3011 W. GRAND BLVD., SUITE 1800 DETROIT, MI 48202-3000
PROJECT MANAGER N. CHARLES ANDERSON (O) 313-831-5564	PROJECT PRINCIPAL JEFF GAINES (O) 313-202-7556
	PROJECT MANAGER CRAIG WOOD (O) 313-202-7771
	PROJECT ARCHITECT RACHEL KOWALCZYK (O) 313-202-7644

PROJECT DESCRIPTION REPLACE ENTIRE ROOF PLUS DAMAGED/ INOPPERABLE GUTTERS AND DOWNSPOUTS. ROOF REPLACEMENT TO MAINTAIN AESTHETIC AND CHARACTER OF THE HISTORIC RESIDENCE.

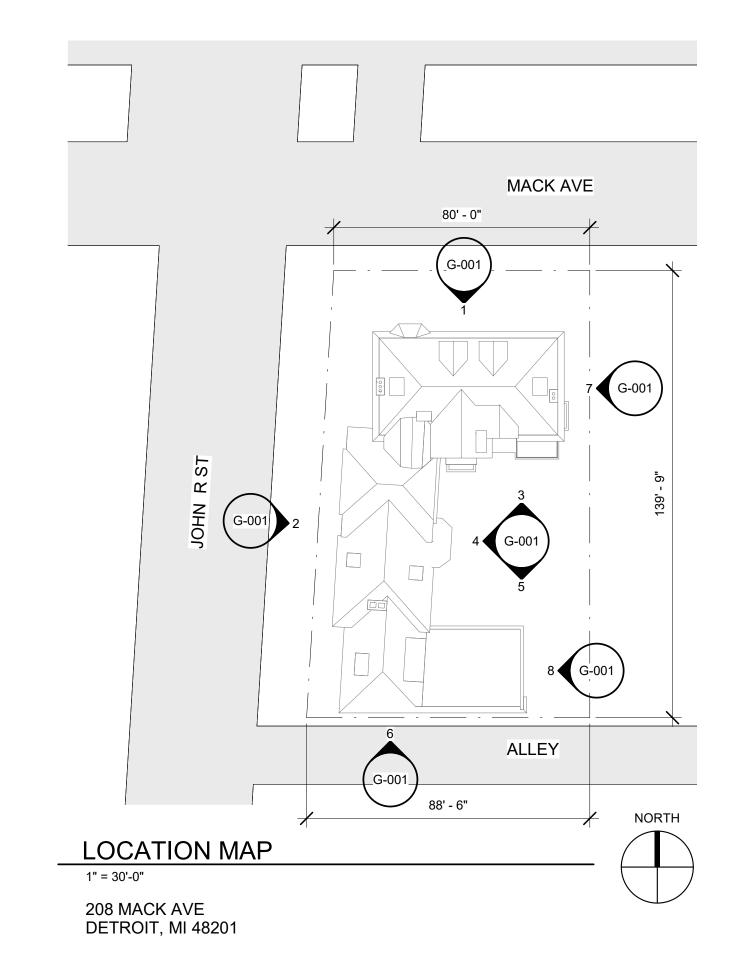





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Restoration 208 Mack Ave. Detroit, MI 48201

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Designed RJK	•	
Drawn By RJK	•	
Checked	•	
Approved	Date	10/16/20
Sheet Title		
COVER SHEET		


STYLE: MORANDO CLOSED SHINGLE TILE FINISH: STANDARD MATTE (SM) COLOR: BURGUNDY BLEND (MID) OVERALL SIZE: 8/4" x11" x1 3/16" PROFILE: VARIOUS PROFILES TO MATCH EXISTING 20 YEAR CROWN WARRANTY MUST MEET ASTM C1187 GRADE 1 ROOF TILE WITH WATER ABSORPTION LESS THAN 2%, CLASS A FIRE RATED PROVIDE MOCK-UP FOR APPROVAL INSTALL PER MANUFACTURER'S INSTALLATION GUIDELINES ACCESSORIES MANUFACTURER TO PROVIDE ROOFING ACCESSORIES INCLUDING: WATERPROCU INIDERLAYMENT, FASTENERS, ICE & WATER MEMBRANE, COPPER FLASHING: SNOW GUARDS TO BE PROVIDED BY TILE MANUFACTURER TILE-B (07 3213) TERRACOTTA TILE - TYPE B (DORMER FACE) MANUFACTURER: LUDOWICI ROOF TILE FLAT SLAB SHNOLE TILE 5/8" FINISH: PLAT SLAB SHNOLE TILE 5/8" FINISH: PATABORA MATTE (SM) OVERALL SIZE: 6" x12" x5/8" PROFILE: VARIOUS PROFILES TO MATCH EXISTING WARRANTY: 20 YEAR CROWN WARRANTY MUST MEET ASTM C1167 GRADE 1 ROOF TILE WITH WATER ABSORPTION LESS THAN 2%, CLASS A FIRE RATED MR (07 5300) MR ELASTOMERIC MEMBRANE ROOF THICKNESS: 0.060 INCH, MINIMUM THICKNESS: 0.060 INCH, MINIMUM SHEET WIDTH: 7 BINCH, MINIMUM, FACTORY-FABRICATE INTO LARG POSSIBLE LEAK WARRANTY: PROVIDE 20 YEAR WARRANTY INSULATION MANUFACTURER: FIRESTONE BUILDING PRODUCTS CARLISLE ROOFING SYSTEM JECK WARRANTY: PROVIDE 20 YEAR WARRANTY INSULATION MANUFACTURER: FIRESTONE BUILDING PRODUCTS CARLISLE ROOFING SYSTEM JORIOUS OF THE WATER	
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PROFILE: HALF ROUND, TO MATCH EXISTING ACCESSORIES: HANGER, TO MATCH EXISTING DOWNSPOUTS MANUFACTURER: CLASSIC GUTTER SYSTEMS, LLC MATERIAL: ALUMINUM	
FINISH: PAINT TO MATCH ROOF TILE PROFILE: ROUND CORRUGATED, TO MATCH EXISTING ACCESSORIES: MOUNT BRACKET, TO MATCH EXISTING	
NOT USED NOT USED	

GENERAL NOTES

 EQUIVALENT PRODUCT/ MANUFACTURER WILL BE CONSIDERED. SUBMIT SUBSTITUTION REQUEST FOR ARCHITECTS APPROVAL. REQUEST TO INCLUDE A COMPARATIVE TABLE OF SPECIFIED PRODUCT AND SUBSTITUTION COMPARING ALL ASPECTS OF THE PRODUCTS.

 SUBMIT SHOP, FABRICATION AND SETTING DRAWINGS TO THE CUSTOMER FOR APPROVAL BY BOTH THE ARCHITECT AND THE CONTRACTOR PRIOR TO PRODUCTION OF ANY MATERIAL. CONTRACTOR SHALL BE RESPONSIBLE FOR ALL FIELD DIMENSION VERIFICATION.

3. NOT USED

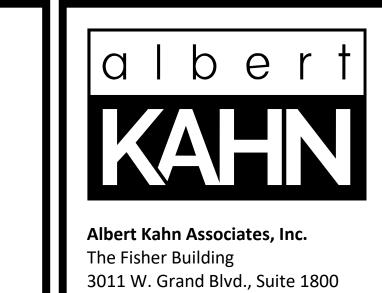

Detroit, Michigan 48202-3000

	Issue History				
	HDC REVIEW	10/16/20			
No.	Description	Date			
Re	Refer To Sheet Index For Complete Issue History				

DISCLAIMER:

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REVIEW ONLY
REVIEW ONLY
REVIEW ONLY
REVIEW ONLY

Key Plan



Urban League / Kahn Home Restoration 208 Mack Ave. Detroit, MI 48201

In Charge R. KOWALCZYK

Designed RJK


Drawn By RJK

Checked

Approved Date 10/16/20
Sheet Title

PRODUCT SPECIFICATIONS

Job No. Sheet No. 3 G-002

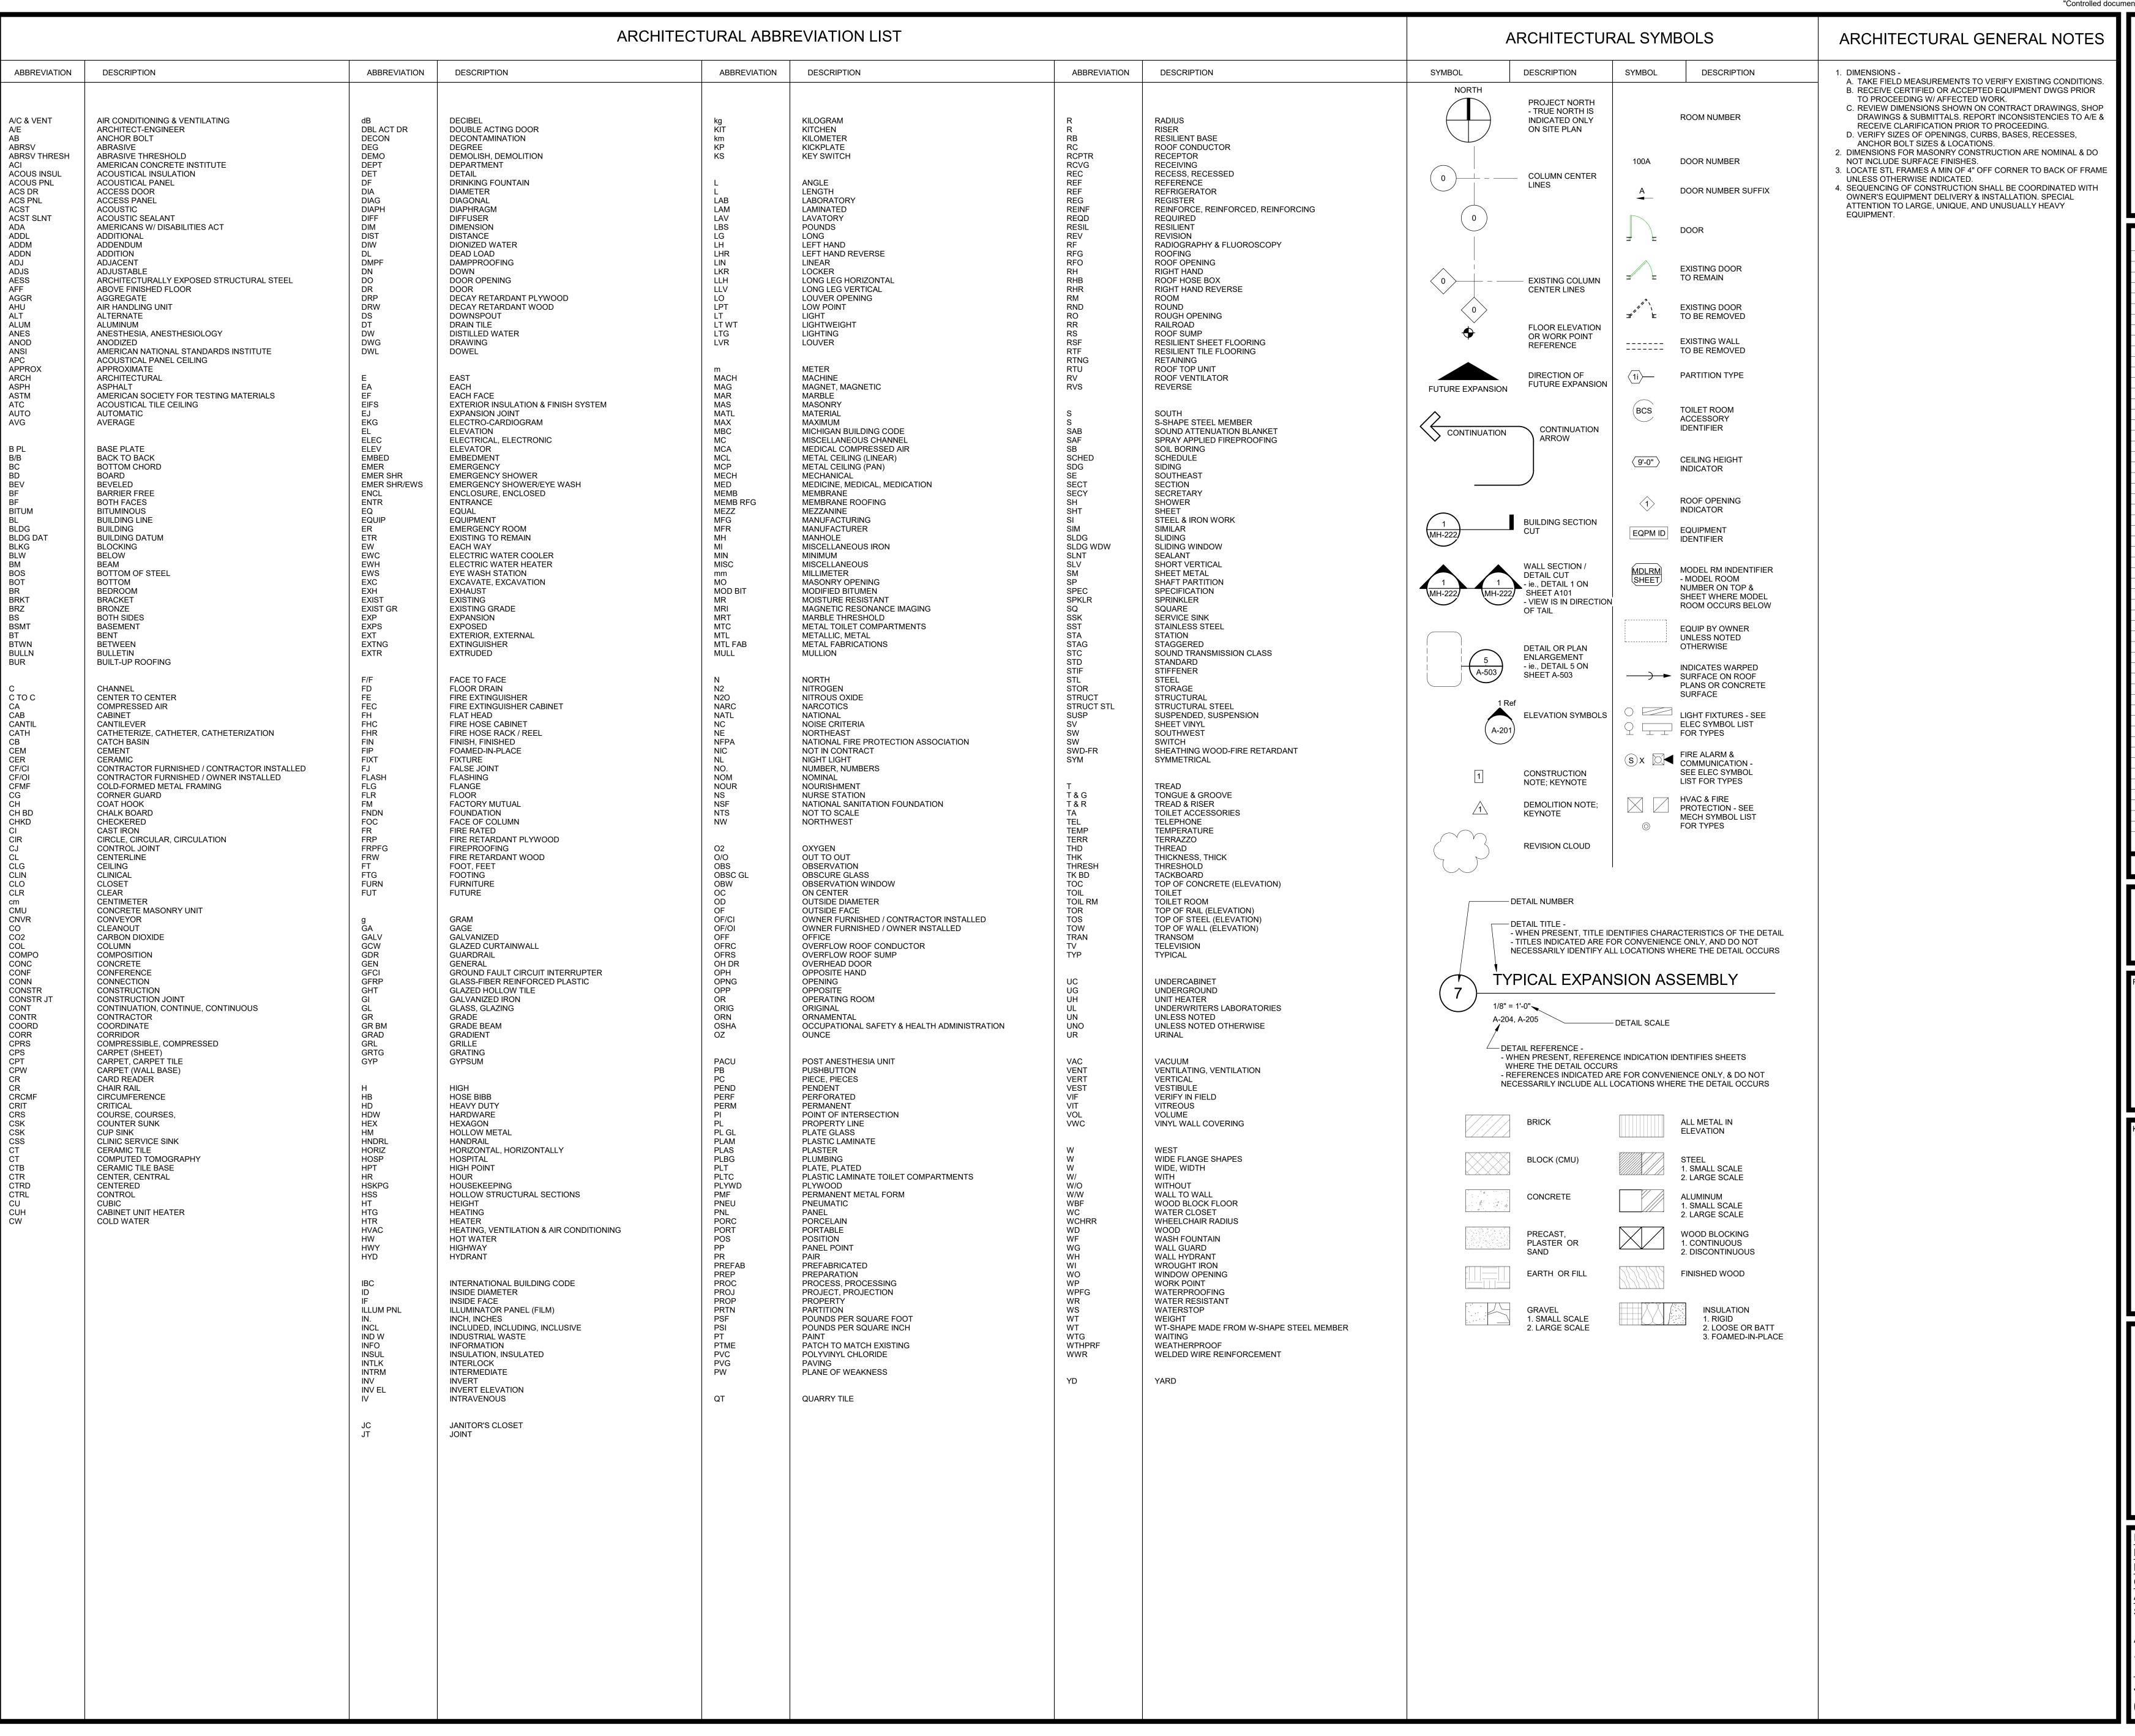

Albert Kahn Associates, Inc. The Fisher Building

3011 W. Grand Blvd., Suite 1800

Detroit, Michigan 48202-3000

Issue History HDC REVIEW No. Description Refer To Sheet Index For Complete Issue History

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Urban League / Kahn Home Restoration 208 Mack Ave.

Detroit, MI 48201

Designed RJK Drawn By RJK Checked Date 10/16/20

ABBREVIATIONS. SYMBOLS, & NOTES

Sheet No A-001



1908 (ESTIMATED)



1912 (ESTIMATED)



1990 (ESTIMATED)



2000 (ESTIMATED)





2 TYP EXISTING FIELD TILE
12" = 1'-0"




TYP EXISTING HIP

AND HIP STARTER TILE

12" = 1'-0"



4 TYP EXISTING VALLEY

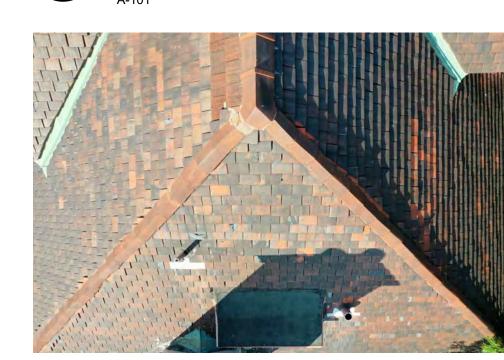

TYP EXISTING RIDGE

AND TERMINAL


12" = 1'-0"



6 TYP EXISTING END BAND

12" = 1'-0"

A-101

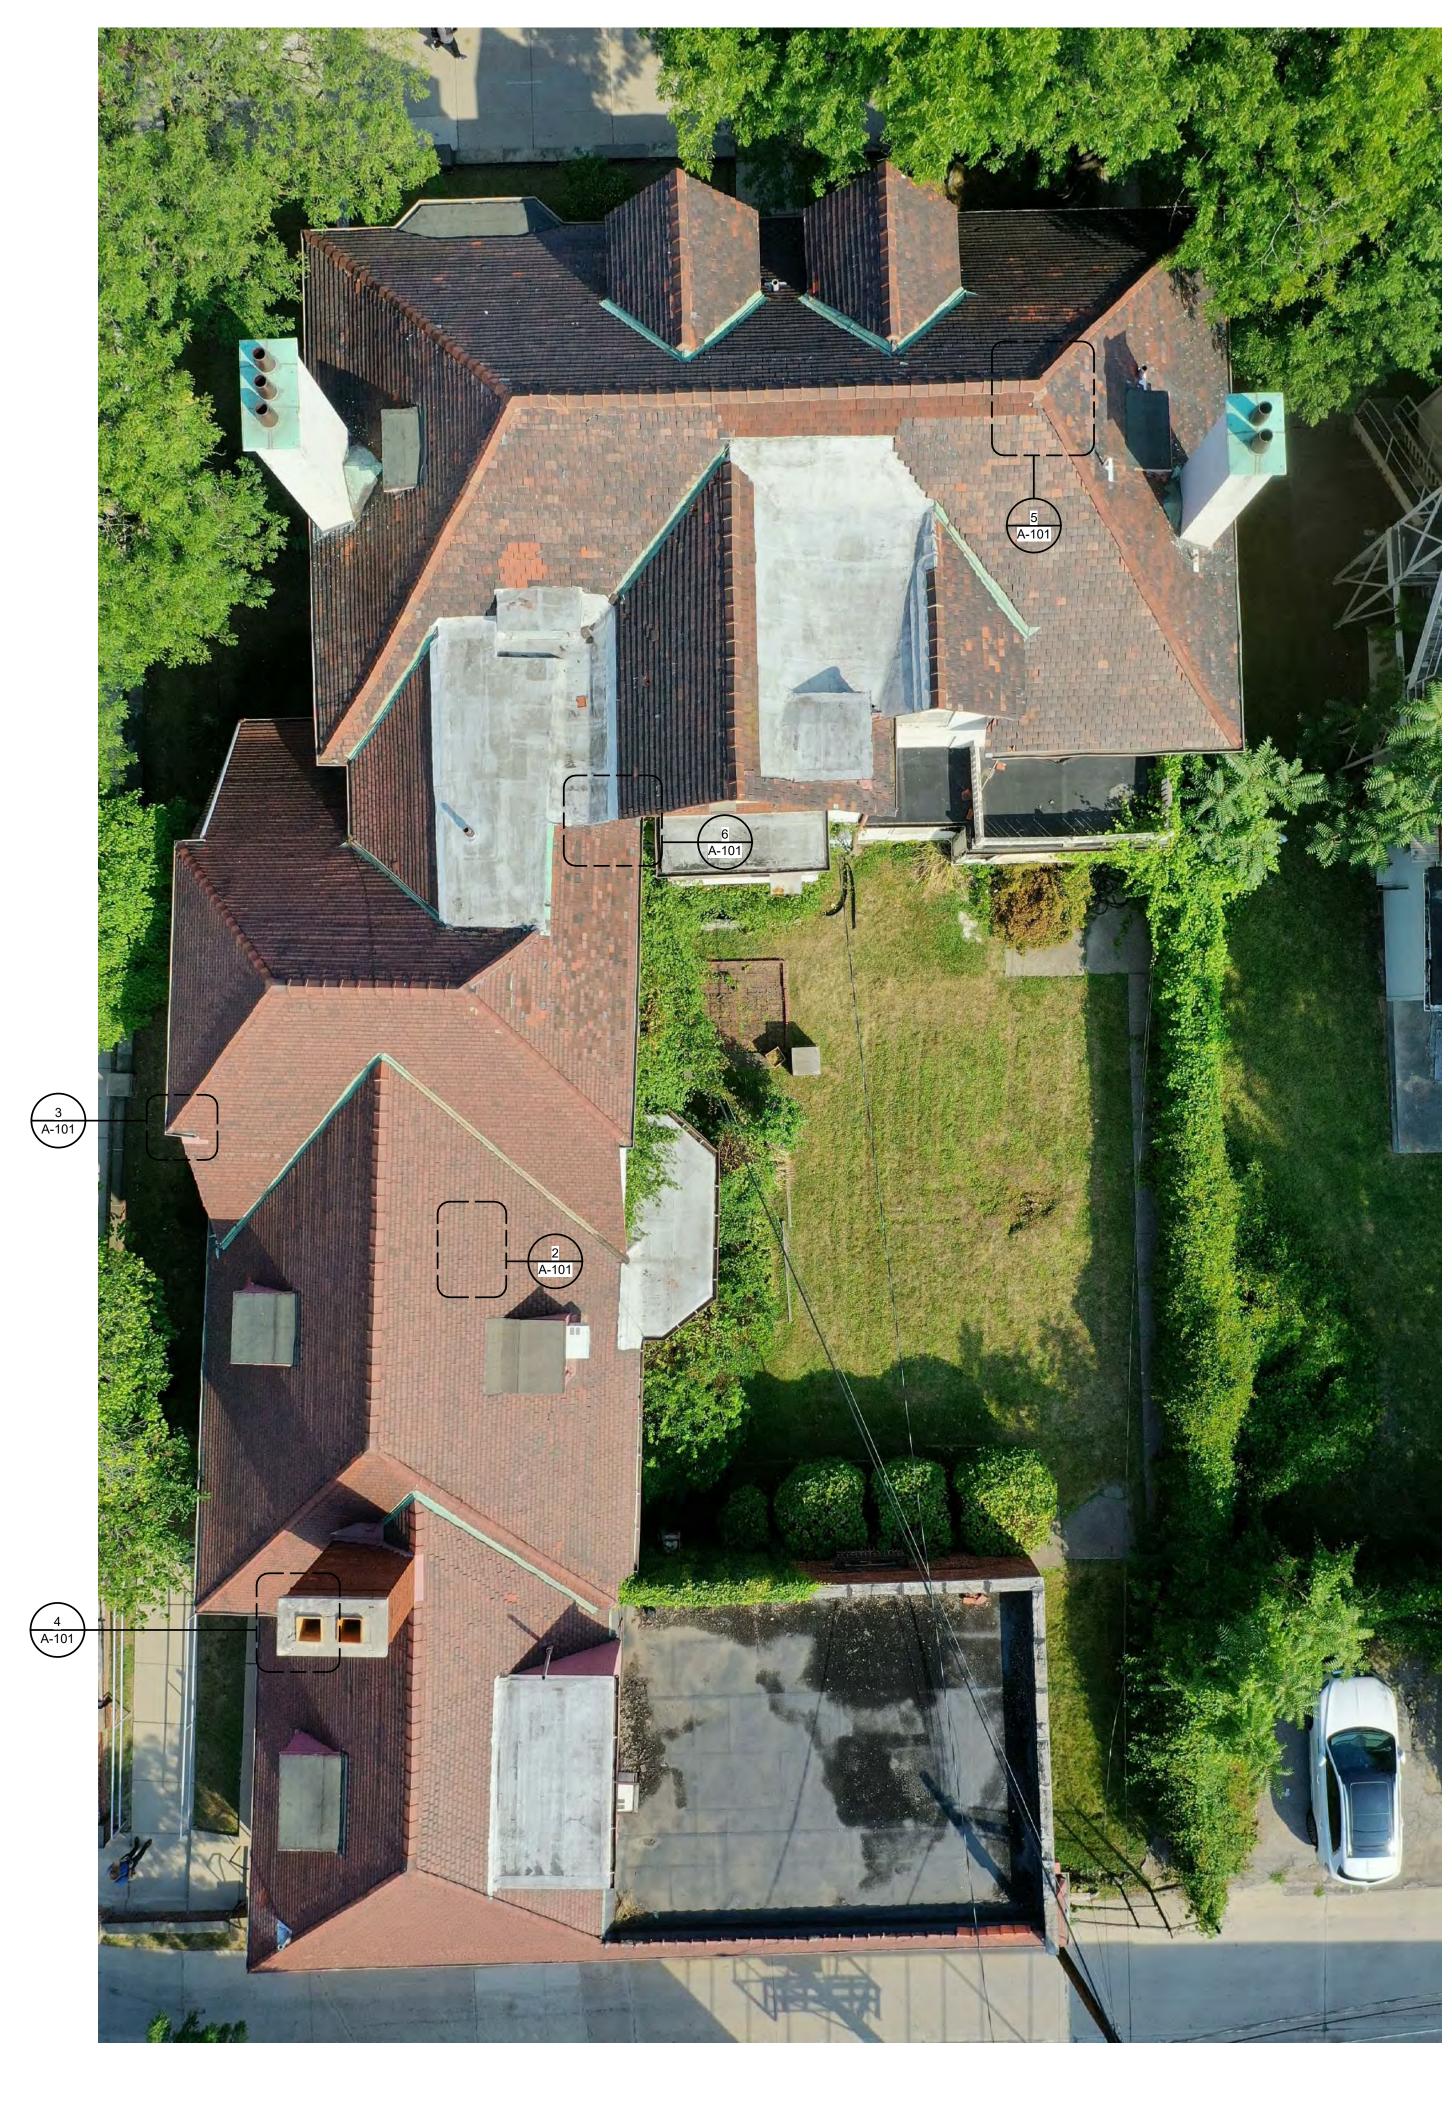

1 EXISTING ROOF CONDITION
12" = 1'-0"



Albert Kahn Associates, Inc.
The Fisher Building
3011 W. Grand Blvd., Suite 1800
Detroit, Michigan 48202-3000

	HDC REVIEW	10/16
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REVIEW ONLY
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REVIEW ONLY
CONSTRUCTION
CONSTRUCTION

Key Plan



Urban League / Kahn Home Restoration 208 Mack Ave. Detroit, MI 48201

In Charge R. KOWALCZYK

Designed RJK

Drawn By RJK

Checked

Approved Date 10/16/20

Sheet Title

EXISTING ROOF


CONDITION

ob No. Sheet No. A 10

Sheet No. A-101

6/20 No. t No.

The Fisher Building

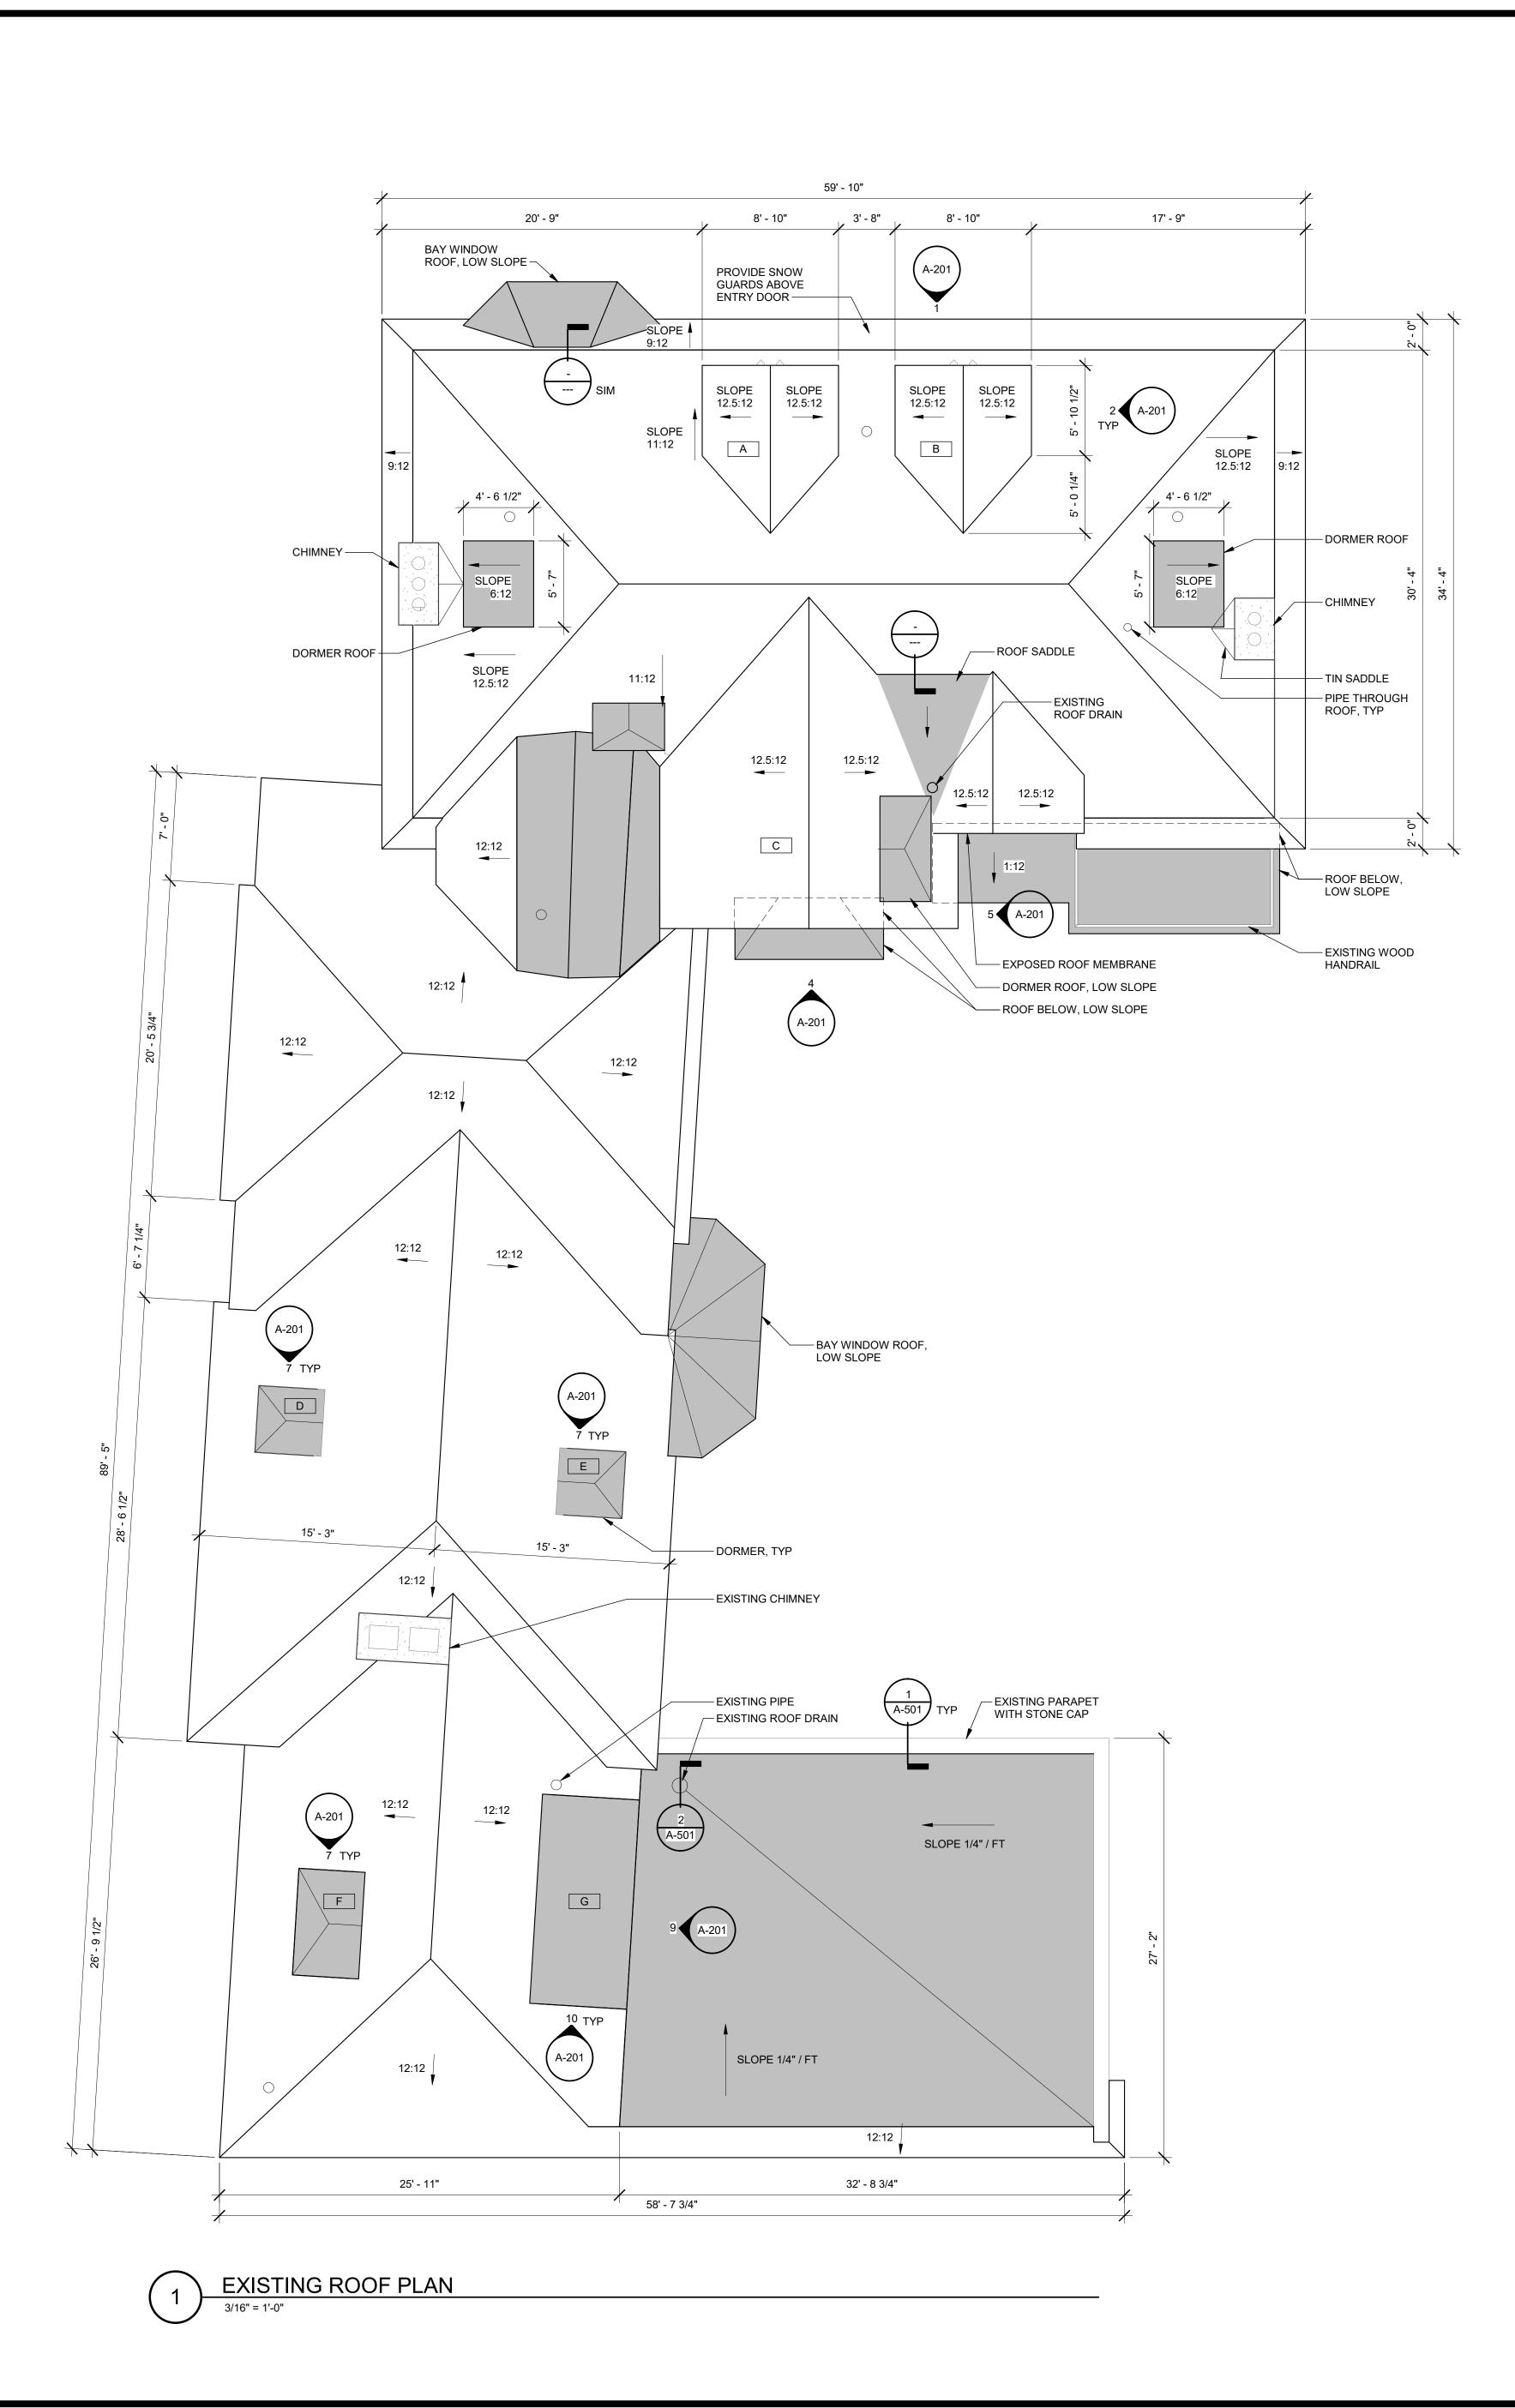

GENERAL DEMOLITION NOTES

REMOVE AND SLAVAGE EXISTING ROOF TILE AND RETURN TO OWNER

2. REMOVE VEGETATION WHERE REQUIRED TO

PERFORM WORK

NOT USED

4. NOT USED

GENERAL ROOF PLAN NOTES

1. REPAIR GUTTERS AND DOWNSPOUTS WHERE DAMAGED OR INOPERABLE

2. REFER TO A-001 FOR SPECIFICATION INFORMATION 3. REPAIR DAMAGED WOOD ROOF DECK WITH LIKE

CONTRACTOR TO FIELD VERIFY EXISTING DIMENSIONS AND ROOF SLOPES

5. PROVIDE COPPER FLASHING AT VALLEYS

ROOF PLAN LEGEND

MEMBRANE ROOF ASSEMBLY (MR)
- ELASTOMERIC MEMBRANE ROOF - MECHANICALLY FASTENED
- 1/2" COVER BOARD - SLOPED INSULATION - WEATHER BARRIER - EXISTING CONCRETE ROOF DECK

TILE ROOF ASSEMBLY (TILE-A)
- TERRACOTTA ROOF TILE
- FURRING STRIPS - UNDERLAYMENT - EXISTING 2x6 T&G WOOD ROOF DECK

X DORMER TAG



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Refer To Sheet Index For Complete Issue History

No. Description



Urban League / Kahn Home Restoration 208 Mack Ave.

In Charge R. KOWALCZYK

Designed RJK

Drawn By RJK

Detroit, MI 48201

Checked

ROOF PLAN

Sheet No. A-110

Date 10/16/20


Albert Kahn Associates, Inc.


3011 W. Grand Blvd., Suite 1800 Detroit, Michigan 48202-3000

The Fisher Building





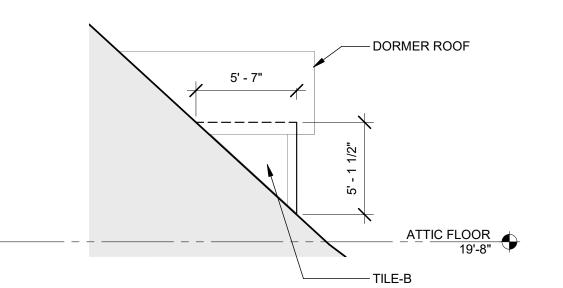

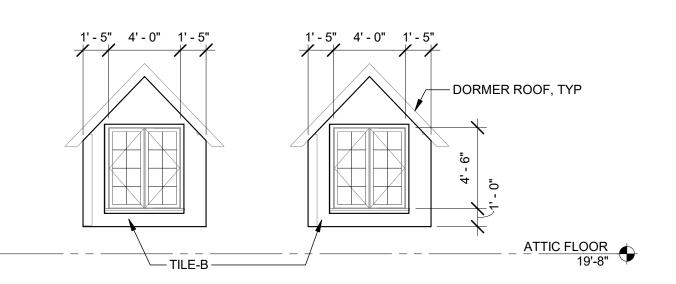













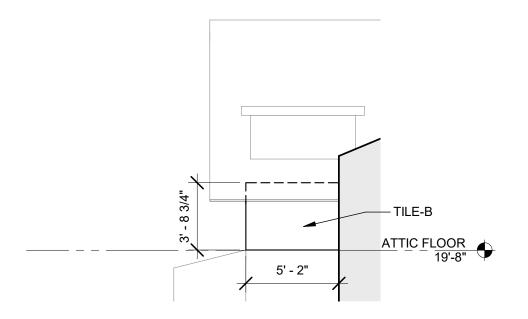

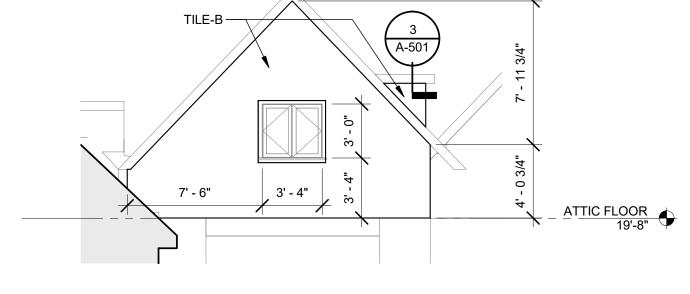

DORMER C IMAGES

12" = 1'-0"

DORMER C ELEVATION

3/16" = 1'-0"
A-110


DORMER C ELEVATION

3/16" = 1'-0"
A-110



DORMER D, E & F IMAGES




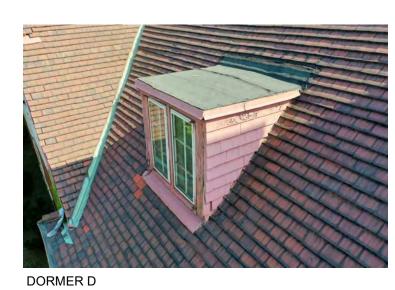








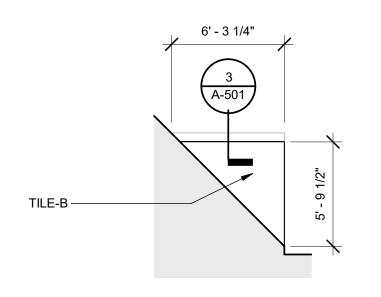

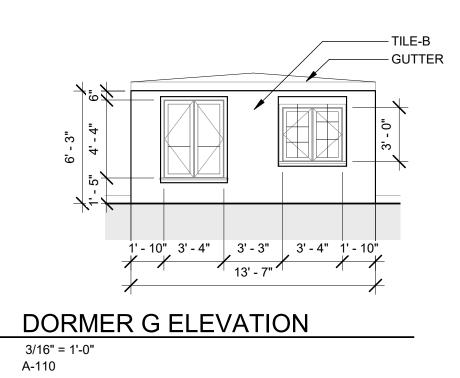

DORMER D, E & F ELEVATION

3/16" = 1'-0"
A-110

DORMER G IMAGES
12" = 1'-0"





HDC REVIEW

Refer To Sheet Index For Complete Issue History

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No. Description



Urban League / Kahn Home Restoration 208 Mack Ave. Detroit, MI 48201

In Charge R. KOWALCZYK

Designed RJK


Drawn By RJK Checked

ELEVATIONS


Approved

Sheet No. A-201

Date 07/20/20

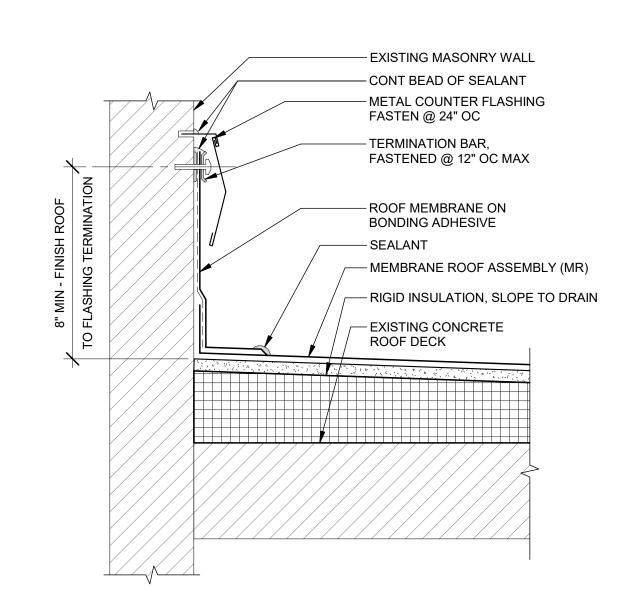


1 FLASHING AT BEARING WALL

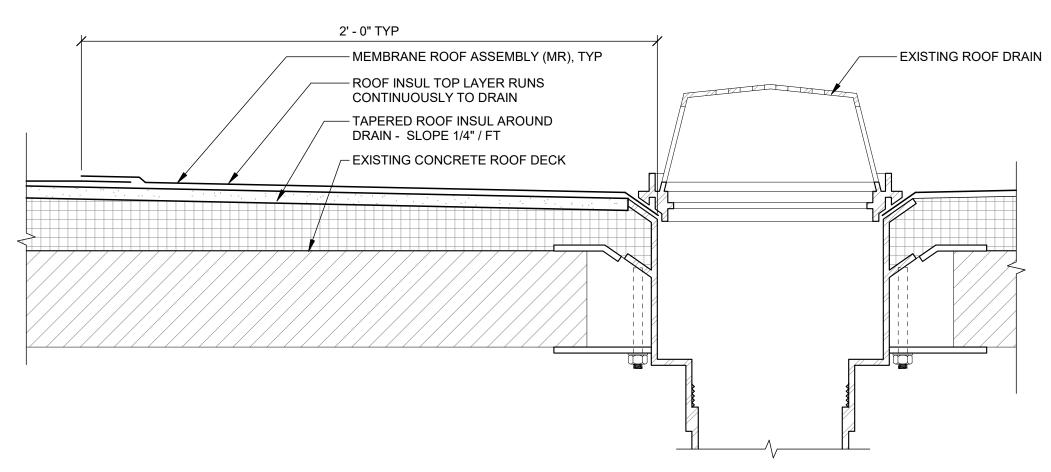

2 ROOF DRAIN - FLAT CONCRETE SLAB

3" = 1'-0"
A-110

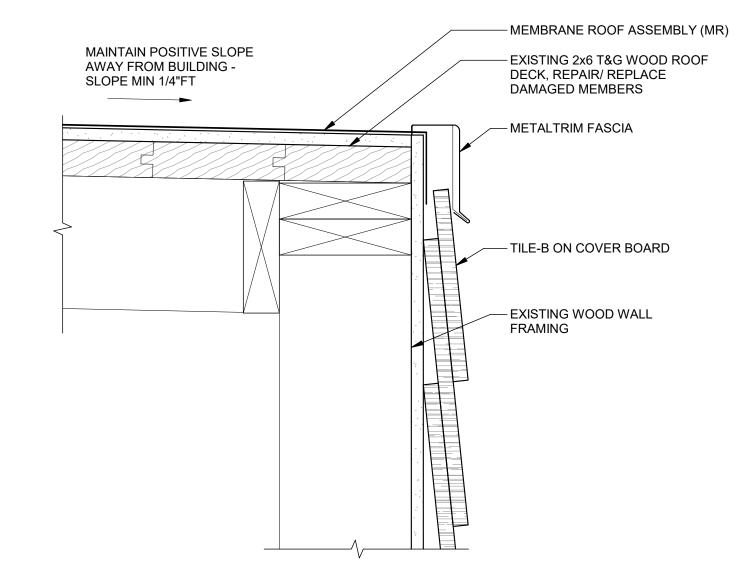

ROOF DETAIL AT DORMER

3" = 1'-0"
A-201



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REVIEW ONLY
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CONSTRUCTION

Key Plan



Urban League / Kahn Home Restoration 208 Mack Ave. Detroit, MI 48201

In Charge R. KOWALCZYK

Designed RJK

Drawn By RJK

Checked

Approved Date 10/16/20

Sheet Title

FTAILS

ob No. Sheet No. 00293-J0 A-501

COLORS OF LUDOWICI






BURGUNDY BLEND M10

Ludowici colors are not painted on the surface, but fired in under extreme temperatures to ensure they retain their original tones and hues for many years to come. Color is included in our 75-year material warranty.

For more information on Ludowici colors, please see the *Art and Science of Ludowici Color* on the back of this card.

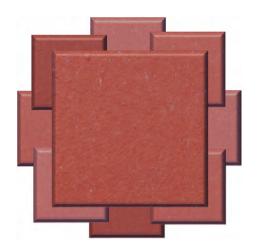

Partial representation of expected color range shown.

THE ART AND SCIENCE OF LUDOWICI COLOR



Creating the color of a terra cotta roof tile is part science and part art. There is always a range of tones within any given color. It is impossible to produce a monochromatic terra cotta roof tile.

In most cases, color is applied by spraying the surface of wet tile with glaze (a mixture of glass frit, silicas and pigments) prior to firing. At kiln temperatures over 2000 degrees Fahrenheit, the spray components fuse onto the surface, becoming an integral part of the tile itself.

Some colors are made from a two-step process involving a base coat and overspray. These colors will naturally display a broader range in tones as the overspray varies in its coverage of the base coat. A broad range will also be produced with colors utilizing high iron content.

The variation of tones within a selected color is affected by many production factors including:

- Temperature variations in the kiln;
- Position of each tile in the kiln;
- Spray patterns and resulting coverage; and
- Subtle natural differences in clay, pigment and frit composition.

The range of tones that arise from the manufacturing process is a normal and very desirable feature of natural clay tile, imparting richness, character and a more dimensional appearance to the roof. Variation in tones should never be considered a defect or flaw. The range of colors produced may vary with each firing process.

Leaded Glazes

Recognizing that leaded glazes represent a serious and real threat to the safety of workers and the environment, Ludowici discontinued their use many years ago. Clay tile roofs found on historic buildings often used leaded glazes and matching those colors using today's non-leaded glazes is virtually impossible as the tile color is profoundly impacted by glaze chemistry. While exact color match is not possible, rest assured that Ludowici's custom color development team will make the closest match possible.

Blending Colors

Color blending, wherein several different colors of terra cotta roof tile are mixed on a roof (such as red, brown and gold), provides the designer or architect an opportunity to create a subtle or dramatic, one-of-a-kind design statement. Diamond or other geometric patterns can also be created.

Ludowici technical service specialists can assist in estimating the amounts of tile needed from design renderings. In addition, we can provide information on blends from previous orders for comparative purposes or for artistic inspiration. When working with blends pay careful attention to fittings. They can be produced entirely in one color or reflect the percentages of colors in the blend.

In addition, Ludowici design specialists highly recommend constructing a test patch of no less than 50 tiles as a final check prior to ordering. As with all shipments of Ludowici tile, contractors must take care when loading the roof with a blend of colors so that mix and percentages of color are uniformly maintained.

Enduring Color

As our color is fired in and chemically bonded with the tile substrate, Ludowici terra cotta roof tiles will not lose their original intensity or color under normal environmental conditions. Natural clay red (unglazed) tile ages minimally too. And unlike some hard roofing products, the surface of Ludowici tile will never become marred by unsightly white salt deposits (efflorescence).

However, in areas subject to pollution, especially those with acid rain, the surface of the tiles may become weathered or subject to deposits that can slightly alter color over time. Matte finishes are more susceptible than high-gloss finishes.

Ludowici color is so durable that colorfastness is included in our 75-year material warranty. See warranty documents for specific details and limitations.

FLAT SLAB SHINGLE TILE







Ludowici's flat slab shingle tile has a smooth surface and square butt creating a clean look suitable to any architectural style. Flat slab tiles are available in $\frac{3}{8}$ " and $\frac{5}{8}$ " thicknesses and standard and custom matte colors, mists and blends. See the *Colors of Ludowici* brochure for more information about our extensive color program.

PHYSICAL CHARACTERISTICS

CHARACTERISTIC	FLAT SLAB SHINGLE TILE 3/8"	FLAT SLAB SHINGLE TILE 5/8"	PROFILE
Weight Per Square	1300 lbs.	2000 lbs.	
Pieces Per Square	480 pcs.	480 pcs.	
Overall Size	6" x 12" x 3/8"	6" x 12" x 5/8"	
Exposure	6" x 5"	6" x 5"	
Minimum Slope	5:12	5:12	
Color Blends	Available in all standard For more information about Ludowici's color pro		
Base Texture	Sm Also available in custom textures. Please see the 7		

APPROVALS & CERTIFICATIONS

- Miami-Dade NOA No: 12-0904.14
- State of Florida Approval No: FL 13777
- ASTM C1167 Grade 1 Roof Tile With Water Absorption Less Than 2%
- Class A Fire Rated

LUDOWICI WARRANTY

All Ludowici tiles are manufactured in the United States and carry a 75-year warranty against color fading and manufacturing defects. For complete warranty details, please visit www.ludowici.com.





GREEN ATTRIBUTES

Ludowici terra cotta is an energy-efficient, sustainable choice for your new roof.
Learn more about our green story in the Ludowici *Green Promise* brochure.










Photos are for representation purposes only and should not be used for final product selection. Tiles ordered should be chosen from actual samples available at the time of order. Ludowici reserves the right to alter and adjust products, colors and finishes at any time. Please contact a sales representative for more information.

FLAT SLAB SHINGLE TILE



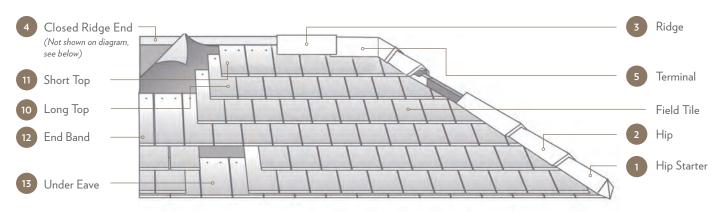

HIP & RIDGE			Visit www.ludo	wici.com to download a	detailed product sheet	on Hip, Ridge and Dec	orative Hip Starters.
PROFILE	1 HIP STARTER	2 HIP	3 RIDGE	CLOSED RIDGE END		5 TERMINAL	
V-Hip & Ridge Trim Group	V-Hip Starter	V-Hip	V-Ridge	V-Closed Ridge End	V- 2 Hip 1 Ridge Terminal		
#118/#211 Hip & Ridge Trim Group	#168 Hip Starter	#118 Hip Roll	#211 Ridge	#211 Closed Ridge End	#118/#211 2 Hip 1 Ridge Terminal		
Circular Cover Hip & Ridge Trim Group	CC-Hip Starter	CC-Hip	CC-Ridge	CC-Closed Ridge End	CC- 2 Hip 1 Ridge Terminal	CC-Low Bump 2 Hip 1 Ridge Terminal	
#102/#206 Hip & Ridge Trim Group	#152 Hip Starter	#102 Hip Roll	#206 Ridge	#206 Closed Ridge End	#102/#206 2 Hip 1 Ridge Terminal	#405 High Bump 2 Hip 1 Ridge Terminal	#406 High Bump Gable Terminal
Old Style Trim Group	Bonnet Hip Starter*	Bonnet Hip Roll* Aries Hip Plate*	Interlocking Ridge				

^{*} Roof slope on each intersecting roof plane needs to be identical to use these pieces.

FITTINGS					
PROFILE	10 LONG TOP	SHORT TOP	12 END BAND	UNDER EAVE	HEADER COURSE
Actual Size	6" x 9"	6" x 5"	3" x 12"	6" x 7"	6" x 12"
Exposure	6" x 5"	6" x 2"	3" x 5"	6"	6" x 9"
Weight	2.1/2.8 lbs./pc.	1.2/1.6 lbs./pc.	1.4/1.9 lbs./pc.	2.0/2.7 lbs./pc.	3.7 lbs./pc.

MORANDO CLOSED SHINGLE TILE







Morando Closed Shingle is Ludowici's smallest interlocking tile. It has a smooth surface and thicker butt than our original Heritage Closed Shingle, but may be customized with a number of custom textures. Its clean look is suitable for a full range of architectural styles. Morando Closed Shingle tiles are available in all standard and custom matte colors, mists and blends offered by Ludowici. See the *Colors of Ludowici* brochure for more information about our extensive color program.

PHYSICAL CHARACTERISTICS

CHARACTERISTIC	MORANDO CLOSED SHINGLE INTERLOCKING TILE	PROFILE
Weight Per Square	1160 lbs.	
Pieces Per Square	225 pcs.	-
Overall Size	8 ^{3/4} ″ x 11″ x 1 ^{3/16} ″	
Exposure	8" x 8" x 1 ³ /16"	
Minimum Slope	3:12	
Color Blends	Available in all standard and custom matte colors. For more information about Ludowici's color program, please see the <i>Colors of Ludowici</i> brochure.	
Base Texture	Smooth Also available in custom textures.* Please see the Terra Cotta Textures brochure for more information.	

APPROVALS & CERTIFICATIONS

- ASTM C1167 Grade 1 Roof Tile With Water Absorption Less Than 2%
- Class A Fire Rated

LUDOWICI WARRANTY

All Ludowici tiles are manufactured in the United States and carry a 75-year warranty against color fading and manufacturing defects. For complete warranty details, please visit www.ludowici.com.





GREEN ATTRIBUTES

Ludowici terra cotta is an energy-efficient, sustainable choice for your new roof.

Learn more about our green story in the Ludowici *Green Promise* brochure.










Photos are for representation purposes only and should not be used for final product selection. Tiles ordered should be chosen from actual samples available at the time of order. Ludowici reserves the right to alter and adjust products, colors and finishes at any time. Please contact a sales representative for more information.

^{*} Textures available include brushed butt, battered butt, hand roughed, weathered and top sand. Please see a sales representative for more details.

MORANDO CLOSED SHINGLE TILE



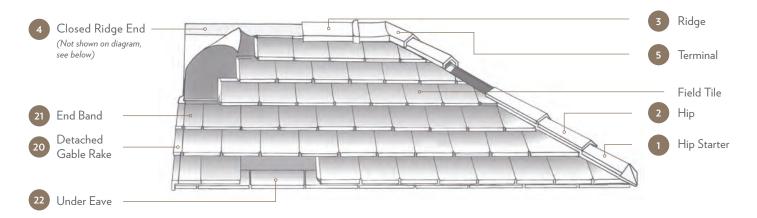

HIP & RIDGE			Visit www.ludov	vici.com to download a	detailed product sheet o	on Hip, Ridge and Deco	rative Hip Starters.
	1	2	3	4 CLOSED RIDGE		5	
PROFILE	HIP STARTER	HIP	RIDGE	END		TERMINAL	
V-Hip & Ridge Trim Group					V-		
	V-Hip Starter	V-Hip	V-Ridge	V-Closed Ridge End	2 Hip 1 Ridge Terminal		
#118/#211 Hip & Ridge				#211	#118/#211		
Trim Group	#168 Hip Starter	#118 Hip Roll	#211 Ridge	Closed Ridge End	2 Hip 1 Ridge Terminal		
Circular Cover Hip & Ridge Trim Group	CC-Hip Starter	CC-Hip	CC-Ridge	CC-Closed Ridge End	CC- 2 Hip 1 Ridge Terminal	CC-Low Bump 2 Hip 1 Ridge Terminal	
#102/#206 Hip & Ridge Trim Group	#152 Hip Starter	#102 Hip Roll	#206 Ridge	#206 Closed Ridge End	#102/#206 2 Hip 1 Ridge Terminal	#405 High Bump 2 Hip 1 Ridge Terminal	#406 High Bump Gable Terminal

FITTINGS				
PROFILE	DETACHED G		END BAND	UNDER EAVE
	Left Rake	Right Rake		
Length	11"		11"	12"
Exposure	8″		8"	12"
Weight	2.8 lb	2.8 lbs./pc.		2.3 lbs./pc.



LUDOWICI FLAT SLAB TILE SAMPLE AT DORMER FACE



LUDOWICI MORANDO TILE SAMPLE ROOF TILE






LUDOWICI BURGUNDY BLEND MATTE FINISH




EXISTING ROOF TILE



LUDOWICI HIP TILE SAMPLE COLOR/ FINISH NOT ACCURATE

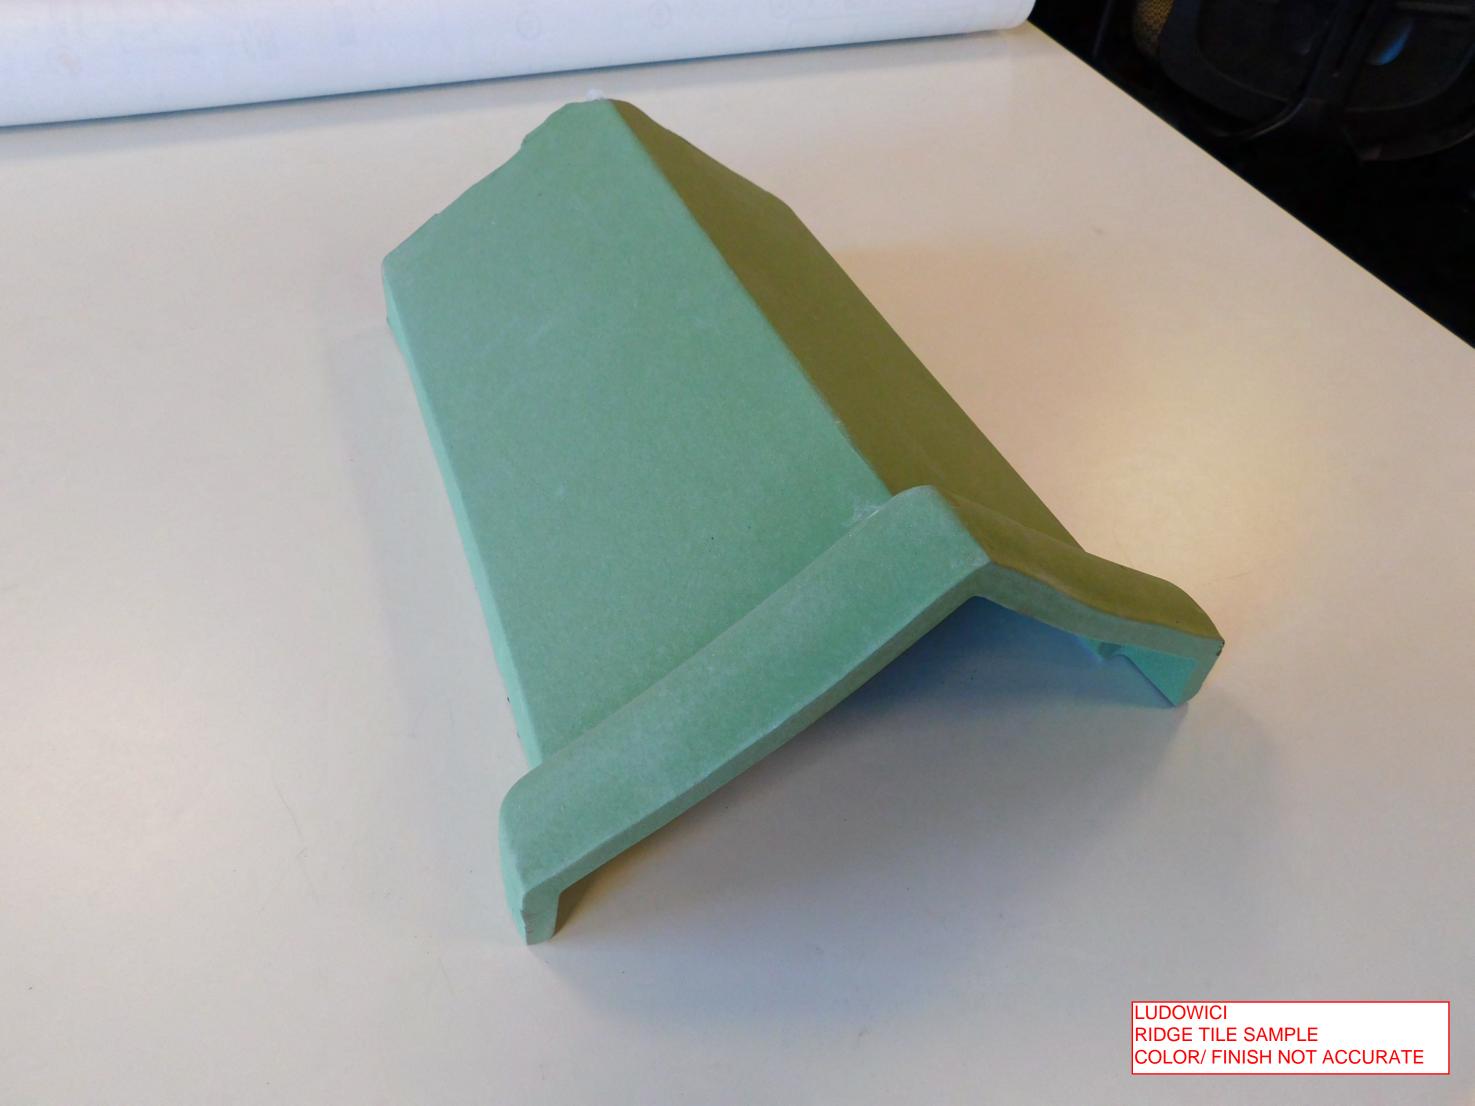

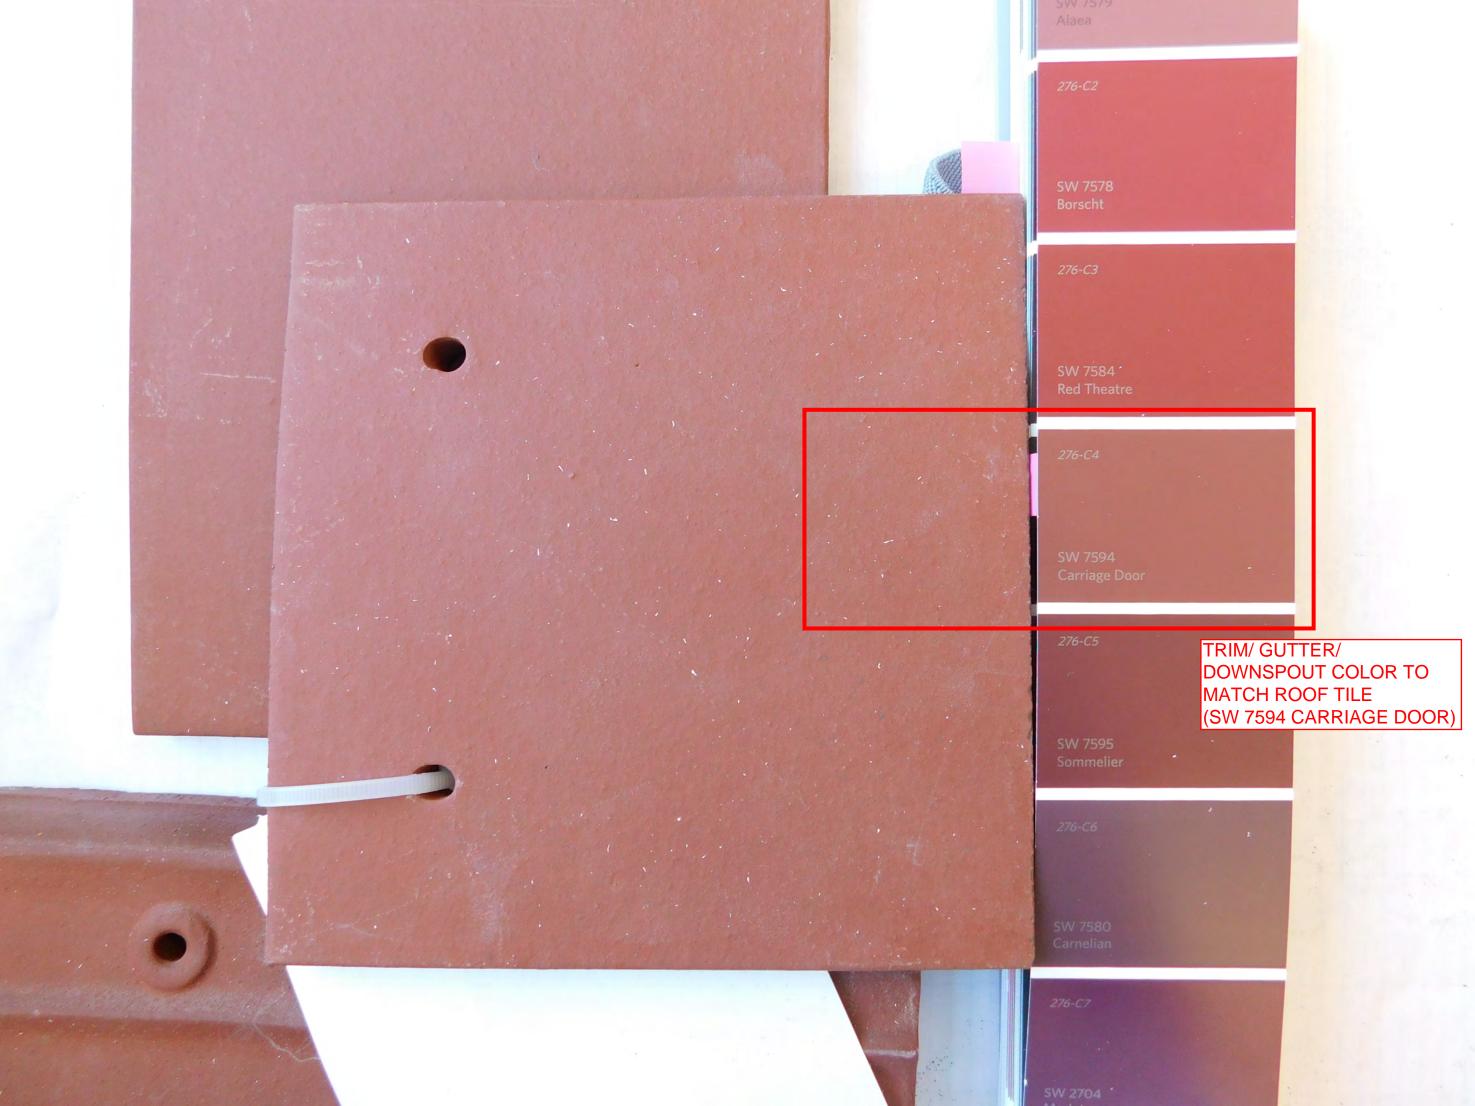



Sure-Seal® EPDM Dusted Non-Reinforced Membranes



Overview

Carlisle's Sure-Seal EPDM Dusted Non-Reinforced membranes are available in thicknesses of 45-mil (1.14 mm) and 60-mil (1.52 mm), widths of up to 50' (15 m), and lengths of up to 200' (60 m). Ideal for new construction and re-roofing applications, this membrane is available in a Fire Retardant (FR) version that is specially formulated to inhibit the spread of flame and meet or exceed code body testing criteria for fire-retardant roofing membranes.

Features and Benefits

- » Carlisle EPDM has 50 years of proven performance and industryleading resistance to weathering, with 41,580 kJ/m² total radiant exposure without cracking or crazing
- » Factory-Applied Tape™ seam technology and a full line of Pressure-Sensitive flashing accessories enhance workmanship quality
- » Dark-colored EPDM is the smart choice in colder climates:
 - Reduces heating costs, which are generally 3-5 times greater than air conditioning costs
 - Reduces carbon footprint by lowering heating costs
 - Reduces safety hazards from snow and ice accumulation
 - Reduces hazardous conditions caused by frost, dew, and ice
 - Reduces the potential for condensation problems
- » Life Cycle Assessment using EPA's TRACI model analyzed EPDM, TPO, PVC and Modified Bitumen:
 - EPDM had the lowest global warming potential
 - EPDM had the lowest acid rain impact
 - EPDM had the lowest contribution to smog

- » Numerous studies and real-world experience confirm that Sure-Seal EPDM's 465% elongation and weathering resistance result in superior hail damage resistance (UL 2218 Class 4 Rating)
- » EPDM is the most dimensionally stable, heat-resistant membrane, and stays flexible even in extremely cold conditions down to -40°F (-40°C): see flexibility/torsion DMA data
- » Wide array of design choices that are UL Classified and FM Approved
- » Industry-leading 15-, 20-, and 25-year warranties are available
- » Carlisle manufactures all the major components of a typical roofing system, including membrane, flashings, tapes, adhesives, sealants, insulations, and insulating cover boards

Carlisle's Factory-Applied Tape Seam Technology

The Factory-Applied Tape process results in a reliable seam with greater peel and shear strengths and no entrapped air bubbles. Consistent placement of the Factory-Applied Tape also maximizes the splice area and results in a high-quality seam. Factory-Applied Tape has a shelf life of one year.

Productivity Boosting Features and Benefits:

- » With Carlisle's Factory-Applied Tape, most of the labor to create seams between membrane panels is completed in a quality-controlled, state-of-the-art environment
- » Factory-Applied Tape is available on all Sure-Seal membranes up to 30' (9 m) in width, providing the fastest way to complete a seam in today's roofing market
- Wider sheets like 16.5', 20', and 25' reduce the frequency of seams compared to 10'-wide sheets

Installation

Sure-Seal 45-mil (1.14 mm) and 60-mil (1.52 mm) membranes are typically utilized in Design A: Fully Adhered (60-mil only), Design B: Ballasted, and Design C: Loose-Laid Protected roofing systems.

For Design A: Fully Adhered Roofing System

Insulation is mechanically attached or adhered to the roof deck. The substrate and membrane are coated with the appropriate Carlisle bonding adhesive. The membrane is then rolled into place and broomed down. To complete seams between two adjoining membrane panels, apply primer to the splice area in conjunction with Carlisle's Factory-Applied Tape. As an alternative, Carlisle's hand-applied SecurTAPE $^{\text{M}}$ may be used.



Sure-Seal EPDM Dusted Non-Reinforced Membranes

For Design B: Ballasted Roofing System

Insulation is loose-laid over the roof deck. Membrane is loose-laid over the insulation and secured with a minimum 10 lbs (4.5 kg) of ballast per square foot. Design C is a similar system with the insulation installed on top of the membrane. To complete seams between two adjoining membrane panels, apply primer to the splice area in conjunction with Carlisle's Factory-Applied Tape. As an alternative, Carlisle's hand-applied SecurTAPE may be used.

Follow these steps for splicing in temperatures below 40°F (5°C):

- 1. Heat the primed area of the bottom membrane with a hot-air gun as the top sheet with Factory-Applied Tape is applied and pressed into place.
- Prior to rolling the splice area with a 2"-wide steel hand roller, apply heat to the top side of the membrane with a hot-air gun. The heated surface should be hot to the touch. Be careful not to burn or blister the membrane.

Review Carlisle specifications and details for complete installation information.

Precautions

- » Use proper stacking procedures to ensure sufficient stability of the materials.
- » Exercise caution when walking on wet membrane. Membranes are slippery when wet.
- » Membranes with Factory-Applied Tape should not be exposed to prolonged jobsite storage temperatures in excess of 90°F (32°C), otherwise the shelf life of the tape may be affected.
- When membranes with Factory-Applied Tape are used in warm, sunny weather, shade the tape end of the rolls until ready to use.
- » Carlisle Factory-Applied Tape has a shelf life of one year.

LEED® Information			
Pre-consumer Recycled Content	5%		
Post-consumer Recycled Content	0%		
Manufacturing Locations	Carlisle, PA Greenville, IL		
Solar Reflectance Index	9		

	Test	SPEC.	Typical		
Physical Property	Method	(PASS)	45-mil	60-mil	
Tolerance on Nominal Thickness, %	ASTM D412	±10	±10	±10	
Weight, lbm/ft2 (kg/m2)			0.29 (1.4)	0.39 (1.9)	
Tensile Strength, min, psi (MPa)	ASTM D412	1305 (9)	1600 (11.0)	1600 (11.0)	
Elongation , Ultimate, min, %	ASTM D412	300	480	465	
Tear Strength, min, lbf/in (kN/m)	ASTM D624 (Die C)	150 (26.3)	200 (35.0)	200 (35.0)	
Factory Seam Strength, min	Modified ASTM D816	Membrane Rupture	Membrane Rupture	Membrane Rupture	
Resistance to Heat Aging* Properties after 28 days @ 240°F (116°C) Tensile Strength, min, psi (MPa) Elongation, Ultimate, min, % Tear Strength, min, Ibf/in (kN/m) Linear Dimensional Change, max, %	ASTM D573 ASTM D412 ASTM D412 ASTM D624 ASTM D1204	1205 (8.3) 200 125 (21.9) ±1.0	1500 (10.3) 225 215 (37.6) -0.4	1450 (10.0) 280 215 (37.6) -0.50	
Ozone Resistance* Condition after exposure to 100 pphm Ozone in air for 168 hours @ 104°F (40°C) Specimen is at 50% strain	ASTM D1149	No Cracks	No Cracks	No Cracks	
Brittleness Temp., max, °F (°C)*	ASTM D746	-49 (-45)	-49 (-45)	-49 (-45)	
Resistance to Water Absorption* After 7 days immersion @ 158°F (70°C) Change in mass, max, %	ASTM D471	+8, -2	+2.0	+2.0	
Water Vapor Permeance* Max, perms	ASTM E96 (Proc. B or BW)	0.10	0.05	0.03	
Flexibility/Torsion DMA	ASTM D5279-08	N/A	225 MPa @ -40°F	225 MPa @ -40°F	
Fungi Resistance	ASTM G21	N/A	0 (No Growth)	0 (No Growth)	
Resistance to Outdoor (Ultraviolet) Weathering* Xenon-Arc, total radiant exposure at 0.70 W/m² irradiance, 80°C black panel temperature	ASTM G155	No Cracks No Crazing 7,560 kJ/m ² 3,000 hrs	No Cracks No Crazing 41,580 kJ/m ² 16,500 hrs	No Cracks No Crazing 41,580 kJ/m ² 16,500 hrs	
At 0.35 W/m² irradiance, 80°C black panel temperature		6,000 hrs	33,000 hrs	33,000 hrs	

*Not a quality control test due to the time required for the test or the complexity of the test. However, all tests are run on a statistical basis to ensure overall long-term performance of the sheeting.

Typical properties and characteristics are based on samples tested and are not guaranteed for all samples of this product. This data and information is intended as a guide and does not reflect the specification range for any particular property of this product.

Note: Sure-Seal Dusted Non-Reinforced EPDM membrane meets or exceeds the minimum requirements set forth by ASTM D4637 for Type I non-reinforced EPDM single-ply roofing membranes.



DensDeck® Roof Board



Overview

DensDeck Roof Board's patented design features a gypsum core with embedded glass mat facers on the top and bottom of the board. DensDeck can be used in a variety of commercial roof systems and provides an excellent thermal barrier as well as exceptional fire, moisture, and wind uplift resistance properties.

DensDeck is primarily used as a cover board over insulation in mechanically fastened roofing applications. Frequently used in wood deck construction to achieve UL code ratings. DensDeck reduces the potential for growth of mold and mildew per ASTM D 3273.

Features and Benefits

- » UL code ratings available for (class A, B, C) unlimited slopes and wood decks
- » FM Approved
- » Improves resistance to foot traffic and hail damage
- » Excellent wind uplift ratings
- » Resistant to deterioration, warping, and jobsite damage
- » 5/8" DensDeck can replace any generic Type "X" gypsum board in any roof assembly in the UL Fire Resistance Directory under the prefix "P"

Installation

DensDeck may be secured with Flexible FAST $^{\text{TM}}$ Adhesive, fastened in accordance with an approved fastening pattern, or mopped with Type III or IV asphalt.

Edge joints should be located on and parallel to deck ribs. End joints of adjacent lengths should be staggered.

- 1. This material shall be installed with ends and edges butted tightly.
- 2. When installed over combustible wood decks or insulations, all joints should be staggered.
- In accordance with approved shop drawings, FM Approved fasteners shall be installed with plates through the roof board, flush with the surface.

Review Carlisle specifications and details for complete installation information.

Precautions

- » Panels must be kept dry before, during and after installation. Apply only as much roof board as can be covered by roof membrane in the same day.
- » ¼" DensDeck is not recommended for vertical parapet applications or for asphalt attachment.
- » In ballasted roofing systems, DensDeck is not an acceptable membrane underlayment.

Ratings and Certifications

- » Manufactured to conform to ASTM C-1177
- » Tested in accordance with ASTM E-84 or CAN/ULC-S102
- » Non-combustible when tested in accordance with ASTM E-136
- » UL code approval for current class A, B, C approvals



DensDeck Roof Board

Properties	1/4" (6.4 mm)	½" (12.7 mm)	5/8" (15.9 mm)
Thickness, nominal	½" (6.4 mm) ± ½16" (1.6 mm)	1/2" (12.7 mm) ± ½32" (.8 mm)	5/8" (15.9 mm) ± ½32" (.8 mm
Width, standard	4' (1219 mm) ± 1/8" (3 mm)	4' (1219 mm) ± 1/8" (3 mm)	4' (1219 mm) ± 1/8" (3 mm)
Length, standard	8' (2438 mm) ± 1/4" (6.4 mm)	8' (2438 mm) ± 1/4" (6.4 mm)	8' (2438 mm) ± 1/4" (6.4 mm)
Weight, nominal, lbs./sq. ft. (Kg/m²) ⁷	1.2 (5.9)	2.0 (9.8)	2.5 (12.2)
Surfacing	Fiberglass mat	Fiberglass mat	Fiberglass mat
Flexural Strength ¹ , parallel, lbf. min. (N)	≥40 (178)	≥80 (356)	≥100 (444)
Flute Spanability ²	25/8" (67 mm)	5" (127 mm)	8" (203 mm)
Permeance³, Perms (ng/Pa• S• m²)	>50 (2850)	>35 (1995)	>32 (1824)
R Value ⁴ , ft ² • °F• hr/BTU (m ² • K/ W)	0.28	0.56	0.67
Linear Variation with Change in Temp., in/in °F (mm/mm/C°)	8.5 x 10 ⁻⁶ (15.3 x 10 ⁻⁶)	8.5 x 10 ⁻⁶ (15.3 x 10 ⁻⁶)	8.5 x 10 ⁻⁶ (15.3 x 10 ⁻⁶)
Linear Variation with Change in Moisture	6.25 x 10 ⁻⁶	6.25 x 10 ⁻⁶	6.25 x 10 ⁻⁶
Water Absorption ⁵ , %	5	5	5
Compressive Strength ⁶ , psi nominal	900	900	900
Surface Water Absorption, grams, nominal ¹	1.0	1.0	1.0
Flame Spread, Smoke Developed (ASTM E84)	0/0	0/0	0/0
Bending Radius	5' (1524 mm)	8' (2438 mm)	12' (3658 mm)

¹ Tested in accordance with ASTM C473 method B.

² Tested in accordance with ASTM E661.

LEED® Information					
Manufacturing Location ¹	Total Recycled Content ²	Pre-Consumer Recycled Content ²	Post-Consumer Recycled Content ²		
Acme, TX	0%	0%	0%		
Antioch, CA	0%	0%	0%		
Ft. Dodge, IA	0%	0%	0%		
Las Vegas, NV	0%	0%	0%		
Lovell, WY	0%	0%	0%		
Newington, NH	30%	30%	0%		
Savannah, GA	0%	0%	0%		
Tacoma, WA	14%	14%	0%		
Wheatfield, IN	94%	94%	0%		

 $^{^{\}rm I}$ Manufacturing locations subject to change. Please visit www.gpgypsum.com and click on Sustainability.

Carlisle and FAST are trademarks of Carlisle. DensDeck is a registered trademark of Georgia-Pacific Gypsum LLC.

⁴ Tested in accordance with ASTM C518 (heat flow meter).

⁵ Tested in accordance with ASTM C1177.

³ Tested in accordance with ASTM E96 (dry cup method).

⁶ Tested in accordance with ASTM C473.

⁷ Represents approximate weight for design and shipping purposes. Actual weight may vary based on manufacturing location and other factors.

 $^{^{2}}$ Recycled content subject to change +/- 1.0%.

³ Based on ICC Evaluation Service Verification of Attributes Report for Dens® brand products issued August 1, 2009. www.saveprogram.icc-es.org



HP-F POLYISO Insulation



Overview

Carlisle's HP-F Polyiso is a rigid roof insulation panel composed of a closed-cell polyisocyanurate foam core manufactured on-line to an impermeable foil facer on both sides.

Features and Benefits

- » Foil facer to provide low vapor permeability
- » Approved for direct application to steel decks

Panel Characteristics

» Available in 4' x 4' (1220 mm x 1220 mm) and 4' x 8' (1220 mm x 2440 mm) panels in thickness of 1" (25 mm) to 3.0" (76.2 mm)

Applications

» Single-ply roof systems (ballasted, mechanically attached)

HP-F Polyiso Thermal Values				
Thickness	R-value*	Flute Spanability		
1.00" (25 mm)	6.5	25/8"		
1.50" (38 mm)	10.0	43/8"		
2.00" (51 mm)	13.3	43/8"		
2.50" (64 mm)	17.0	43/8"		
3.00" (76 mm)	20.3	43/8"		

^{*}Initial thermal values are determined by using ASTM C518 at 75°F mean temperature and are typical values for impermeable faced products.

Installation

Ballasted Single-Ply Systems

Each HP-F panel is loosely laid on the roof deck. Butt edges and stagger joints of adjacent panels. Install the roof covering according to Carlisle's specifications.

Mechanically Attached Single-Ply Systems

Each HP-F panel must be secured to the roof deck with fasteners and plates appropriate to the deck type. Butt edges and stagger joints of adjacent panels. Install the roof covering according to Carlisle's specifications.

Review Carlisle specifications and details for complete installation information.

Precautions

Insulation must be protected from open flame and kept dry at all times. Install only as much insulation as can be covered the same day by completed roof covering material. Carlisle will not be responsible for specific building and roof design by others, for deficiencies in construction or workmanship, for dangerous conditions on the jobsite or for improper storage and handling. Technical specifications shown in this literature are intended to be used as general guidelines only and are subject to change without notice. Call Carlisle for more specific details, or refer to PIMA Technical Bulletin No. 109: Storage & Handling Recommendations for Polyiso Roof Insulation.



HP-F POLYISO Insulation

Typical Properties and Characteristics				
Physical Property	Test Method	Value		
Compressive Strength	ASTM D1621 ASTM 1289	20 psi** minimum (138 kPa, Grade 2)		
Dimensional Stability	ASTM D2126	2% linear change (7 days)		
Moisture Vapor Transmission	ASTM E96 12.10	<1 perm (57.5 ng/(Pa•s•m²))		
Water Absorption	ASTM C209	<1% volume		
Service Temperature		-100° to 250°F (-73)°C to 122°C		

^{**}Also available in 25 psi minimum, Grade 3

Typical properties and characteristics are based on samples tested and are not guaranteed for all samples of this product. This data and information is intended as a guide and does not reflect the specification range for any particular property of this product.

Codes and Compliances

- » ASTM C1289, Type I, Grade 2 (20 psi), Grade 3 (25 psi)
- » International Building Code (IBC) Section 2603
- » UL Standard 790, 263 and 1256: Component of Class A Roof Systems (refer to UL Roof Materials' system directory)
- » FM® Standards 4450/4470: Class 1 approval for steel roof-deck constructions (refer to FM RoofNavSM)
- » California Code of Regulations, Title 24, Insulation Quality Standard License #TI-1418
- » Third-party certification with the PIMA Quality Mark for Long-Term Thermal Resistance (LTTR) values
- » CAN/ULC 5704, Type 2 & 3, Class 2


NOTE: Please be aware the Federal Specification HH-I-1972/GEN has been replaced.

LEED® Information			
Pre-consumer Recycled Content	9%		
Post-consumer Recycled Content	0%		
Manufacturing Locations	Smithfield, PA Franklin Park, IL Tooele, UT Terrell, TX Lake City, FL		




Foamed plastic as roof deck construction material with resistance to an internal fire exposure only for use in construction no.(s) 120 and 123. See UL Directory of Products Certified for Canada and UL Roofing Materials and Systems Directory. 99DL.




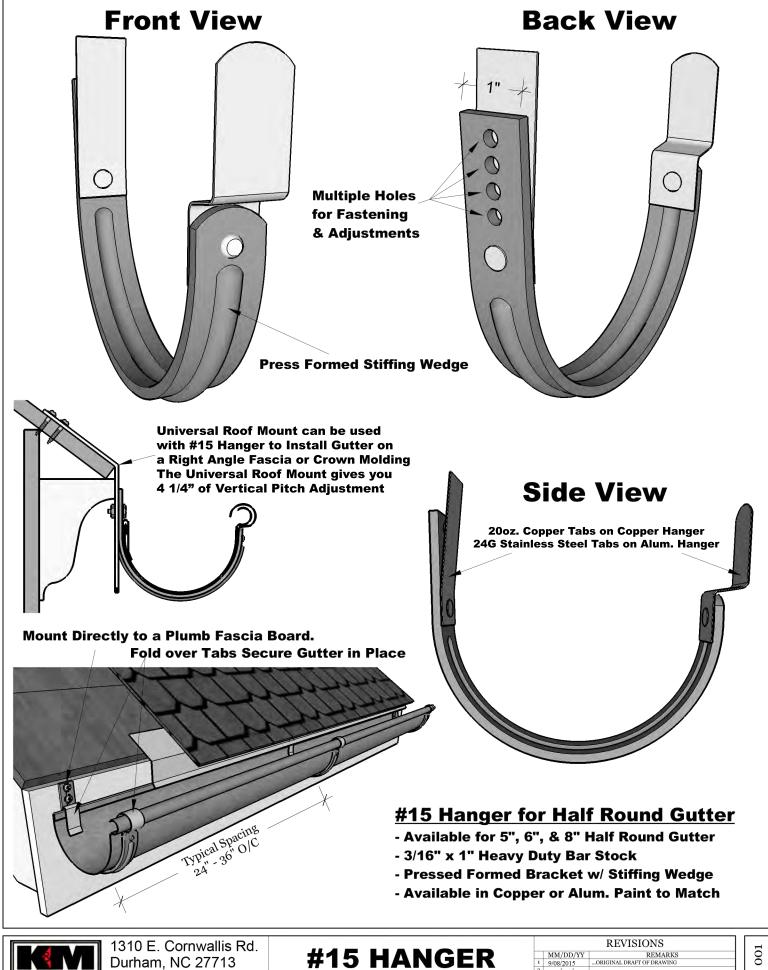

P-(919) 544-8887 F- 544-8898 info@kmsheetmetal.com - www.kmsheetmetal.com

HALF ROUND GUTTER

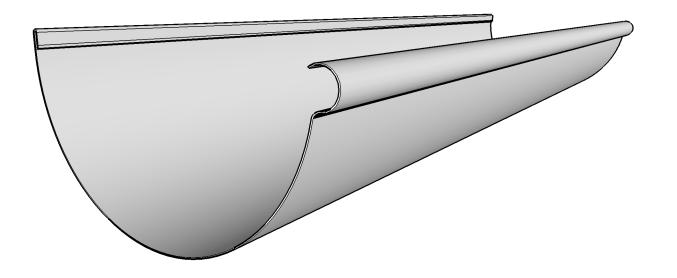

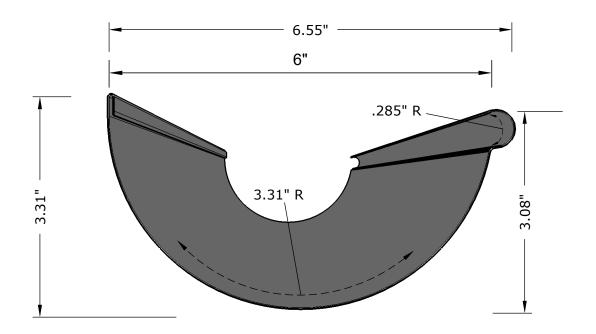

Notes:

Our Reverse Bead Half Round Gutter is Roll Formed and available in lengths up to 40'0" Available in the following materials:
.027 & .032 Aluminum
16 oz. or 20 oz. Copper & Lead Coated Copper
24 ga. Kynar Finish Steel
24 ga. Galvalume
.7mm & .8mm Zinc

	1310 E. Cornwallis Rd.			
SHEET METAL	Durham, NC 27713 P-(919) 544-8887 F- 544-8898			
info@kmsheetmetal.com - www.kmsheetmetal.com				

6" Reverse Bead		REVISIONS		
		MM/DD/YY	REMARKS	
		6/25/2015	ORIGINAL DRAFT OF DRAWING	
		//		
Half Round Gutter		//		
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Products About Us

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= \$0.00 °

Estimate Forms

Installations



Estimate Forms

Installations

4" x .024 Aluminum Smooth Round & Corrugated Downspout

Home / 4" Round Downspout / 4" x .024 Aluminum Smooth Round & Corrugated Downspout







\$19.50 - \$23.50

Downspout sections are available in 10' pre-cut

lengths. We recommend corrugated downspout for areas of the country that experience snow and ice. Corrugation allows for expansion in the event of ice build-up in the downspout. Corrugation also helps hide nicks and dents from daily exposure.

Smooth downspout is recommended mainly for southern climates. We take great care in the packaging of our downspout; however, flawless sections of smooth downspout cannot be guaranteed due to potential improper handling by the freight carriers.

All of our 4" aluminum smooth downspout has one expanded end for ease of installation, allowing for a a far superior installation to the traditional crimped joint.



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Our Aluminum Downspout is available in Smooth and Corrugated styles in these four Standard Colors: high gloss white, low gloss white, dark bronze and royal brown (see Aluminum Color Chart below). Note: We can make **Select Color Corrugated Downspout and Elbows** for a \$100.00 up charge (one charge per color, per order).

Downspout orders LONGER than 6' will be shipped via truck and subject to a MINIMUM shipping fee of \$150.00

One to three pieces of downspout can be sent UPS. The 10' downspout will be cut into 6' & 4' sections. UPS charges will run in the \$100 range. Please indicate in the "Order Notes" area at checkout whether you want a UPS or freight quote.

Each gutter and downspout order is unique at Classic Gutter Systems. Once you've placed your order on this website, you'll be contacted within 48 hours with a complete, detailed quote including packaging and shipping costs.

COLOR

Choose an option

STYLE

Choose an option

- 1 +